### **ABBREVIATIONS**

```
LAM.
                                                      LAMINATED
                                           LBS.
           DIAMETER
                                                     POUNDS
                                           LEV.
           NUMBER
                                                     LEVEL
                                           LOC.
                                                     LOCATION
           ACOUSTIC CEILING TILE
           AREA DRAIN
                                                     MAXIMUM
                                           M.D.F.
            ADJACENT, ADJUSTABLE
                                                     MEDIUM DENSITY FIBERBOARD
                                           MECH.
           ABOVE FINISHED FLOOR
                                                     MECHANICAL
                                            MEMB.
            ALUMINUM
                                                     MEMBRANE
                                            MEZZ.
           ACOUSTIC TILE CEILING
                                                      MEZZANINE
                                           MFR.
                                                      MANUFACTURER
                                                      MINIMUM
           BETWEEN
                                                     MISCELLANEOUS
           BLOCKING
                                                     MASONRY OPENING
                                                     MODULE
           BOTTOM OF
                                           M.S.
                                                     MACHINE SCREW
                                            MTD.
                                                     MOUNTED
           BEARING
                                                     METAL
 BTWN.
           BETWEEN
                                                     NOT IN CONTRACT
 CER.
                                           NO.
           CERAMIC
                                                     NUMBER
                                           NOM.
           CONTROL JOINT
                                                     NOMINAL
                                           N.T.S.
            CENTER LINE
                                                     NOT TO SCALE
           CEILING
                                                      OVERALL DIMENSION
 CLR.
           CLEAR
                                                     ON CENTER
           CONCRETE MASONRY UNIT
                                                     OUTSIDE DIAMETER
           COLUMN
                                                     OPENING
 CONC.
           CONCRETE
                                                     OPPOSITE
           CONSTRUCTION
                                                      OWNER FURNISHED / CONTRACTOR INSTALLED
 CONT.
           CONTINUOUS
                                                      OWNER FURNISHED / OWNER INSTALLED
 COOR.
            COORDINATE
                                                      OWNER FURNISHED / VENDOR INSTALLED
           COLD ROLLED
                                                     OVAL HEAD
           CERAMIC TILE
                                                     OVERHEAD
 CTSK.
           COUNTERSINK
                                                     PLASTIC LAMINATE
                                                      PROPERTY LINE
DCA.
           DRILLED CONCRETE ANCHOR
                                           PARA
                                                     PARALLEL
 DET.
           DETAIL
                                           PERP.
                                                     PERPENDICULAR
           DRINKING FOUNTAIN
                                                     PLATE
           DIAMETER
                                                      PLYWOOD
 DIM.
                                            PLYWD.
           DIMENSION
                                                      PLYWOOD
           DIRECTORY
                                                     PAINT
                                            PTD.
           DISPENSER
                                                     PAINTED
                                           PTN.
                                                     PARTITION
           DOOR
                                           Q.T.
           DETAIL
                                                     QUARRY TILE
           DRAWING
                                                     QUANTITY
           EXISTING
                                           RAD.
           EACH
                                                     RADIUS
           EXPANSION JOINT
                                           R.D.
                                                     ROOF DRAIN
            ELEVATION
                                                     REFER TO
 ELEC.
                                            REQD.
            ELECTRICAL
                                                      REQUIRED
                                           RES.
                                                     RESILIENT
                                            RESIL.
           EQUIPMENT
                                                      RESILIENT
                                           R.H.
                                                     ROUND HEAD
 EXIST.
           EXISTING
                                                     ROOM
           EXPANSION
                                                     ROUGH OPENING
           EXPANSION JOINT
                                                     SOLID CORE
                                            SCHED.
                                                     SCHEDULE
                                           SECT.
S.E.D.
S.F.
           FLOOR DRAIN
                                                     SECTION
           FIRE EXTINGUISHER
                                                     SEE ELECTRICAL DRAWINGS
           FIRE EXTINGUISHER CABINET
                                                     SQUARE FOOT
           FLAT HEAD
                                                     SHEET
           FIRE HOSE CABINET
                                                     SIMILAR
                                                     SEE MECHANICAL DRAWINGS
FLR.
           FLOOR
                                                     SHEET METAL SCREW
 FLUOR.
                                           S.P.D.
           FLUORESCENT
                                                    SEE PLUMBING DRAWINGS
           FACE OF
                                           S.S.D.
STD.
STL.
STRUCT.
           FACE OF STUD
FACE OF WALL
                                                     SEE STRUCTURAL DRAWINGS
 F.O.W.
                                                     STANDARD
           FULL SIZE
           FURRING
                                                     STRUCTURAL
           FUTURE
                                                     SUSPENDED
           GAUGE
           GALVANIZED
                                            T.O.
T.O.C.
T.O.S.
           GRAB BAR
                                                     TOP OF
                                                     TOP OF CONCRETE
            GARBAGE DISPOSAL
           GYSUM WALLBOARD
                                                     TOP OF STEEL
           GYSUM WALLBOARD
                                                      UNDERWRITERS LABORATORIES INC.
           HOLLOW CORE
                                                      UNLESS OTHERWISE NOTED
           HARDWOOD
           HOLLOW METAL
                                                     VINYL COMPOSITION TILE
           HORIZONTAL
                                            VEN.
                                                     VENEER
                                            VER.
                                                      VERIFY
                                            VEST.
           HOT ROLLED
                                                     VESTIBULE
                                                     VERTICAL
                                                     VERIFY IN FIELD
           INSIDE DIAMETER
                                                     VINYL WALL COVERING
           INSIDE FACE
            INSULATION
                                                     WATER CLOSET
           INTERMEDIATE
                                                     WALL COVERING
                                                     WATERPROOF
           JOIST
JOINT
                                                     WATER RESISTANT
```

### CAMBULG LEGEND

SAMB	OLS LEGEND						
Å	NORTH INDICATOR	X'-X"	INDICATES LEVEL LINE, CONTROL POINT, OR DATUM	_	DETAIL DRAWING REFERENCE SYMBOL:		REVISION
		<del>•</del>	MATCH LINE				DESIGNATION; MOST CURRENT REVISION
$\langle X \rangle$	COLUMN REFERENCE GRID		ALIGN FACE OF FINISH WITH ADJACENT FACE OF FINISH	X AX.X	DETAIL NUMBER TO BE REFERENCED SHEET NUMBER TO BE		SHOWN CLOUDED ON DRAWING; RE: REVISION LIST IN
-			LIMIT OF DEMOLITION / NEW CONSTRUCTION		REFERENCED		TITLE BLOCK
			CENTERLINE		LARGE SCALE PLAN OR ENLARGED SECTIONAL		
<b>→</b>	KEY NOTE DESIGNATION; RE: KEY NOTE LEGEND	XXX X'-X"	CLG. HT. AT DESIGNATED LOCATION; TYPICAL CLG. HT. IS 8'-0" U.O.N.	$\bigcirc$ $\bigcirc$ $\bigcirc$	DETAIL:  DETAIL NUMBER TO BE REFERENCED	XXX XXX	ROOM NAME
N X F	DRAWING REFERENCE; ARROW INDICATES	OF H	DOOR DESIGNATION MARK - SEE DOOR SCHEDULE		SHEET NUMBER TO BE	XXX	SQUARE FOOTAGE
" AX.X	BIRECTION OF VIEW	$\bigcirc$	WINDOW OR LOUVER DESIGNATION		KEFEKENGED		

MARK SEE WINDOW SCHEDULE

# UC HASTINGS COLLEGE OF LAW INTERIOR IMPROVEMENTS

198 & 200 MCALLISTER STREET SAN FRANCISCO, CA 94102

### PROJECT DESCRIPTION:

PLANNING CODE

INTERIOR IMPROVEMENT OF 198 McALLISTER BASEMENT OFFICE WITH NEW WALL CONSTRUCTION, CEILING, AND LIGHTS. RECONFIGURATION OF EXISTING MECHANICAL SYSTEM TO NEW CEILING GRID. INTERIOR IMPROVEMENT OF 200 McALLISTER 4TH FLOOR CONVERSION OF COMPUTER LAB TO 3 OFFICES, OPEN WORK AREA, AND CONFERENCE ROOM. NEW CEILINGS, POWER, DATA, AV. RELOCATE SPRINKLERS, LIGHTS, AND HVAC AS REQUIRED. CONVERSION OF 2 STORAGE ROOMS INTO CONFERENCE ROOM AND OPEN WORK AREA

INTERIOR IMPROVEMENT OF 198 McALLISTER BASEMENT OFFICE B27 & LOCKER ROOM B25 INTO ONE STORAGE SPACE FOR HIGH DENSITY SHELVING. NEW CEILING AND FLOOR AS REQUIRED. TO BE STARTED WHEN ROOM B21 IS COMPLETE.

198 McALLISTER STREET PROPERTY LOCATION: 200 McALLISTER STREET SAN FRANCISCO, CA 94102 SAN FRANCISCO, CA 94102 OCCUPANCY: GROUP B - OFFICE GROUP B - OFFICE AS DEFINED BY CBC SECTION 304 AS DEFINED BY CBC SECTION 304

OFFICE OFFICE INTENDED USE: (NO CHANGE) (NO CHANGE) TYPE OF CONSTRUCTION: TYPE I-B

FIRE SPRINKLERS: FULLY SPRINKLERED FULLY SPRINKLERED **BUILDING STORIES:** 

TOTAL BASEMENT 3380 SQ FT RENOVATED AREA: TOTAL 4th FLOOR 1906 SQ FT

**BUILDING INCREASES:** NONE

TOTAL RENOVATED AREA: 5,286 SQ FT

### ALL WORK SHALL COMPLY WITH:

1. CODE CLASSIFICATION: 2013 CALIFORNIA BUILDING CODES TITLE-24

2013 CALIFORNIA ENERGY CODE 2013 CALIFORNIA MECHANICAL CODE 2013 CALIFORNIA PLUMBING CODE 2013 CALIFORNIA ELECTRICAL CODE

2013 CALIFORNIA FIRE CODE

2013 CALIFORNIA ADMINISTRATIVE CODE 2013 CALIFORNIA GREEN BUILDING CODE, APPENDIX A5 - NONRESIDENTIAL MEASURES

# SHEET INDEX

### ARCHITECTURAL DRAWINGS

SHEET # SHEET NAME COVER SHEET GENERAL NOTES

BASEMENT PLAN AND REFLECTED CEILING PLAN IN 198 MCALLISTER HIGH DENSITY STORAGE PLANS IN 198 MCALLISTER

4th FLOOR PLANS IN 200 MCALLISTER

FINISH SCHEDULE /4TH FLOOR STUDY ROOMS IN 200 MCALLISTER 4th FLOOR CEILING AND DOOR SCHEDULE

4th FLOOR CEILING & POWER PLAN

CEILING DETAILS

DETAILS

### **ALTERNATES**

ALTERNATE 1 - THE CONSTRUCTION OF AND FIT OUT OF ROOMS 448 AND 449 INCLUDING MECHANICAL AND ELECTRICAL WORK.


ALTERNATE 2 - SEE MECHANICAL SPECS.

ALTERNATE 3 - SEE MECHANICAL SPECS FOR ALTERNATE 2B.


ALTERNATE 4- THE CONSTRUCTION AND DEMOLITION ASSOCIATED WITH ROOMS 424,

425, AND 427.

# SCOPE OF WORK DIAGRAM

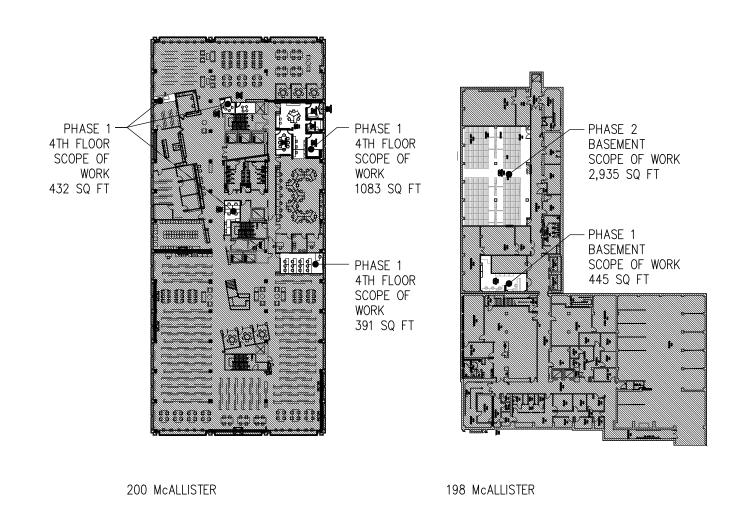

# SITE LOCATION MAP

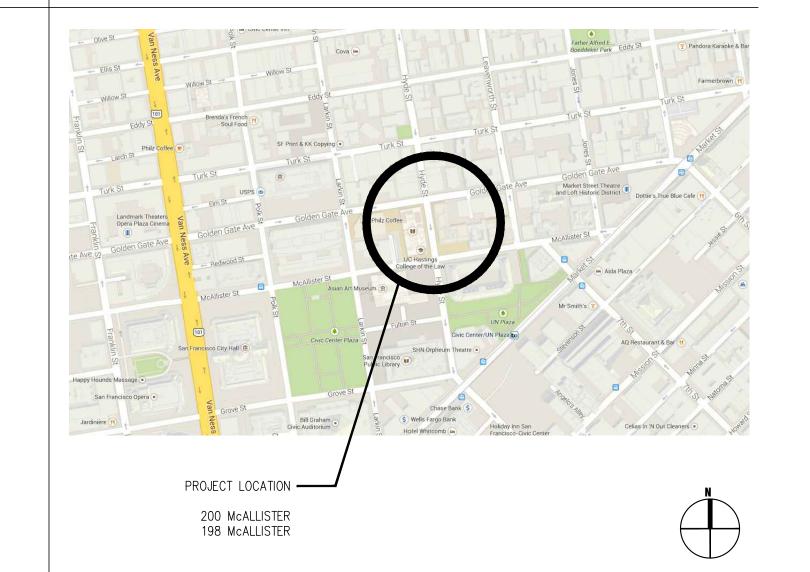

# MKTHINK

### Architects

MKTHINK

Roundhouse One, 1500 Sansome Street San Francisco, CA 94111 p 415 402 0888

f 415 288 3383 mkthink.com

All drawings and written material contained herein constitute original and unpublished work of the architect and may not be duplicated, used or disclosed without written consent of the architect. Accuracy of drawings is for design purposes only. Do not scale off drawings.

Project: Media Services Relocation 200 McAllister Street

Project Number: 491-142

San Francisco, CA



**UC Hastings College of Law** 200 McAllister Street San Francisco, CA

Rev. Issue Date 1.9.14 BID SET

Scale: N/A

Drawing Description:

**COVER SHEET** 

Drawn By: JT

Checked By: JK

Sheet Number:

- 1 A.I.A. DOCUMENT 201, GENERAL CONDITIONS FOR THE 17 NOT USED. PERFORMANCE OF A CONTRACT, ARE HEREBY INCORPORATED INTO THESE DRAWINGS & SHALL BE CONSIDERED AS PART OF THE REQUIREMENTS FOR THE COMPLETION OF WORK.
- 2 THE WORK SHALL CONFORM TO ALL GOVERNING CODES AND ORDINANCES.
- CONTRACTOR SHALL APPLY FOR, OBTAIN & PAY FOR ALL LICENSES & INSPECTIONS AS REQUIRED TO COMPLY WITH ALL STATE, CITY, LOCAL CODES & LAWS.
- PRIOR TO COMMENCING WORK, THE CONTRACTOR, IN CONFERENCE WITH THE BUILDING MANAGER SHALL PREPARE A LIST OF HIS ACTIVITIES THAT WILL NOT, IN ANY WAY EFFECT THE NORMAL OPERATIONS OF THE 18 ALL CONCEALED BLOCKING TO BE FIRE-TREATED WOOD BUILDING & NEIGHBORING TENANTS. PROTECTIVE MEASURES & SCHEDULING SHALL BE ESTABLISHED TO MINIMIZE DISRUPTION & PROTECT PROPERTY NOT RELATED TO THIS PROJECT. PROVIDE THE ARCHITECT WITH A COPY OF THE SCHEDULE & DESCRIPTION OF PROTECTION.

OR SHEETMETAL.

INSTALLATIONS.

MANAGER AND TENANT.

19 IN CASE OF CONFLICT BETWEEN ARCHITECTS AND

THE SCHEDULE FOR ALL TELEPHONE COMPANY

21 ALL WORK SHALL BE PERFORMED DURING REGULAR

BUSINESS HOURS WHENEVER POSSIBLE. WORK

INVOLVING EXCESSIVE NOISE OR DUST, OR WHICH

WOULD OTHERWISE INTERFERE WITH THE NORMAL

OPERATION OF BUSINESS FOR TENANTS SHALL BE

DONE ON AN OVERTIME. NON-REGULAR BUSINESS

OF ALL UTILITIES DETERMINED IN THE COURSE OF

CONTRACTOR SHALL REMOVE SUCH UTILITIES ONLY

CONSTRUCTION DOCUMENTS OR DETERMINED LATER IN

FIELD. DISCONNECT, CUT BACK TO SOURCE, AND CAP

PENETRATIONS CREATED BY REMOVAL OF UTILITES TO

23 "ALIGN" SHALL MEAN TO ACCURATELY LOCATE FINISH

LIFE SAFETY DEVICE, HVAC RISER, ETC, BUILDING

, PRIOR TO DISCONNECTION OF ANY ELECTRICAL RISER,

REPRESENTATIVE IS TO BE NOTIFIED. CONTRACTOR TO

SUBMIT A WRITTEN REQUEST FOR EACH SHUT DOWN.

APPROVAL OF SUCH REQUESTS. CONTRACTOR IS TO

ADHERE TO APPROVED SCOPE OF WORK & SCHEDULE

"TYPICAL" OR "TYP" SHALL MEAN THAT THE CONDITION

THROUGHOUT, UNLESS OTHERWISE NOTED. DETAILS ARE

USUALLY KEYED AND NOTED "TYP" ONLY ONCE, WHEN

THEY FIRST OCCUR. "SIMILAR" MEANS COMPARABLE

VERIFY DIMENSIONS AND ORIENTATION ON PLANS AND

WORK AREAS ARE TO REMAIN SECURE AND LOCKABLE

COORDINATE WITH TENANT AND BUILDING MANAGER TO

THE CONTRACTOR SHALL MAINTAIN FOR THE ENTIRE

27 DURATION OF THE WORK ALL EXITS, EXIT LIGHTING,

CONFORMANCE WITH ALL APPLICABLE CODES AND

ORDINANCES. PROVIDE TEMPORARY SUPPORT IF

28 (INCLUDING "PATH OF ACCESS" AND LOBBY WHERE IT

ALL MANUFACTURED ARTICLES, MATERIALS AND

ERECTED, CLEANED AND CONDITIONED PER

MANUFACTURER'S INSTRUCTIONS. IN CASE OF

DIFFERENCES BETWEEN THE MANUFACTURER'S

CONTRACTOR SHALL NOTIFY THE ARCHITECT, IN

ALL WORK NOTED "BY OTHERS" OR "NIC" SHALL BE

CONTRACT. INCLUDE SCHEDULE REQUIREMENTS FOR

SCHEDULE AND COORDINATE AS REQUIRED TO ASSURE

30 PROVIDED BY OWNER/TENANT OR UNDER SEPARATE

THIS "OTHER" WORK IN CONSTRUCTION PROGRESS

EXAMINATION OF THE SITE AND PORTIONS THEREOF

WITH THE DRAWINGS AND SATISFY HIMSELF AS TO

HE SHALL AT SUCH TIME ASCERTAIN AND CHECK

LOCATIONS OF THE EXISTING STRUCTURES AND

EQUIPMENT WHICH MAY AFFECT HIS WORK. NO

EXAMINATION.

THE GENERAL CONTRACTOR, WHO SHALL COMPARE IT

CONDITIONS UNDER WHICH WORK IS TO BE PERFORMED

ADDITIONAL ALLOWANCES SHALL BE MADE AFTER THE

CONTRACT IS SIGNED FOR ANY EXTRA EXPENSES DUE

TO FAILURE OR NEGLECT ON HIS PART TO MAKE SUCH

31 WHICH WILL EFFECT THIS WORK SHALL BE MADE BY

ORDERLY SEQUENCE OF INSTALLATION.

INSTRUCTIONS AND THE CONTRACT DOCUMENTS, THE

APPLIES TO THIS WORK) SHALL BE PROTECTED FROM

ANY DAMAGE THAT OCCURS BECAUSE OF THIS WORK.

THE SCOPE OF WORK AND ADJACENT AREAS

RESPONSIBILITY OF THE CONTRACTOR.

WRITING, BEFORE PROCEEDING.

FIRE PROTECTIVE DEVICES AND ALARMS IN

CHARACTERISTICS FOR THE CONDITIONS NOTED.

25A WORK WITHIN "BUILDING CORE AREAS" SHALL BE NIC

25 IS REPRESENTATIVE FOR SIMILAR (OR SIM.) CONDITIONS

ADEQUATE TIME IS TO BE GIVEN FOR REVIEW AND

DURING EACH APPROVED SHUT DOWN.

UNLESS OTHERWISE NOTED

ENSURE SECURITY.

NECESSARY.

AFTER CONSULTATION WITH ARCHITECT, OWNER &

WHICH HAVE NOT OTHERWISE BEEN NOTED FOR

REMOVAL IN THE CONSTRUCTION DOCUMENTS.

TENANT. WHETHER PREDETERMINED IN THE

ALL UTILITY SERVICES REMOVED. SEAL ALL

FACES IN THE SAME PLANE.

MATCH ADJACENT CONSTRUCTION AND FINISH.

CONSTRUCTION AS BEING NECESSARY TO BE REMOVED

NOTIFY ARCHITECT REGARDING THESE DISCREPANCIES.

ENGINEERS DRAWINGS IN LOCATING

- THE CONTRACTOR IS RESPONSIBLE FOR CHECKING CONTRACT DOCUMENTS, FIELD CONDITIONS & DIMENSIONS FOR ACCURACY & CONFIRMING THAT THE WORK IS BUILDABLE AS SHOWN BEFORE PROCEEDING WITH CONSTRUCTION. IF THERE ARE ANY QUESTIONS THE CONTRACTOR IS RESPONSIBLE FOR INFORMING THE ARCHITECT IN WRITING & OBTAINING CLARIFICATION FROM THE ARCHITECT BEFORE PROCEEDING WITH WORK IN QUESTION OR RELATED WORK. REQUESTS FOR ADDITIONAL CHARGES WILL NOT BE ENTERTAINED FOR THE CONTRACTOR'S FAILURE TO FORESEE MEANS OF INSTALLING EQUIPMENT INTO POSITION INSIDE STRUCTURES.
- REFERENCES TO MAKES, BRANDS, AND MODELS IS TO  $_{22}$  CONTRACTOR SHALL NOTIFY ARCHITECT IMMEDIATELY ESTABLISH TYPE AND QUALITY DESIRED. SUBSTITUTIONS OF ACCEPTABLE EQUALS WILL NOT BE PERMITTED UNLESS SPECIFICALLY APPROVED IN WRITING BY THE ARCHITECT.
- THE DESIGN CONCEPT OF THIS PROJECT IS BASED ON THE COLOR, DESIGN & TEXTURE OF FINISHED PRODUCTS SPECIFIED. IF THE CONTRACTOR FAILS TO ORDER MATERIALS IN SUFFICIENT TIME FOR ORDERLY INSTALLATION THE ARCHITECT WILL NOT ENTERTAIN ANY REQUEST FOR MATERIAL SUBSTITUTION. INSTEAD, THE CONTRACTOR SHALL PROVIDE & INSTALL TEMPORARY FINISHES OR MATERIALS SATISFACTORY TO THE ARCHITECT & PROVIDE & INSTALL THE SPECIFIED FINISHES OR MATERIALS UPON THEIR ARRIVAL, MONIES WILL BE WITHHELD PENDING SATISFACTORY INSTALLATION OF SPECIFIED FINISHES & MATERIALS.
- THE CONTRACTOR SHALL CONFIRM ALL LEAD TIMES FOR FINISH MATERIALS AT TIME OF BIDDING TO ASSURE AVAILABILITY OF MATERIALS FOR THE PROJECT, AS SCHEDULE REQUIRES. ANY COST FOR SPECIAL HANDLING OR AIR FREIGHT OF MATERIALS IN ORDER TO MEET REQUIRED DEADLINES IS THE RESPONSIBILITY OF THE CONTRACTOR.
- ALL CLEAR DIMENSIONS SHALL BE EXACT WITHIN 1/8" TOLERANCE ALONG FULL HEIGHT AND FULL WIDTH OF WALLS.
- THE CONTRACTOR SHALL PROMPTLY REPORT TO THE ARCHITECT DISCREPANCIES FOUND BETWEEN EXISTING CONDITIONS AND THOSE SHOWN ON THE DRAWINGS SO THAT CLARIFICATIONS MAY BE ISSUED.
- THE CONTRACTOR SHALL PREPARE ALL EXISTING SURFACES AS REQUIRED TO RECEIVE SPECIFIED FINISH. 12 SHOP DRAWINGS & SUBMITTAL MUST BE PROVIDED 26 DURING CONSTRUCTION. CONTRACTOR SHALL FOR ARCHITECT'S APPROVAL BEFORE BEGINNING ANY MILLWORK FABRICATION AND PRIOR TO ORDERING ALL MATERIALS.
- 13 THE CONTRACTOR SHALL PATCH OR OTHERWISE FURNISH AND INSTALL MATERIALS REQUIRED TO MATCH EXISTING CONDITIONS AS NOTED & AS A RESULT OF THE WORK. ANY CONDITIONS REQUIRING DETAILING SHOULD BE BROUGHT TO THE ATTENTION OF THE ARCHITECT. NEW GYPSUM BOARD CONSTRUCTION MEETING EXISTING CONSTRUCTION IN THE SAME PLANE SHALL BE FLUSH, WITH NO VISIBLE JOINTS SHOWING.
- 14 GENERAL CONTRACTOR SHALL COMPLY WITH THE RULES AND REGULATIONS OF THE BUILDING AS TO HOURS OF AVAILABILITY OF ELEVATORS AND/OR LOADING DOCKS FOR THE PURPOSES OF DELIVERY AND ALSO AS TO THE MANNER OF HANDLING MATERIALS, EQUIPMENT AND DEBRIS, TO AVOID CONFLICT AND INTERFERENCE WITH NORMAL BUILDING OPERATION. ALL WORK SCHEDULING SHALL BE SUBMITTED TO BUILDING MANAGER AND TENANT FOR REVIEW AND APPROVAL PRIOR TO COMMENCEMENT OF
- 15 ALL HEIGHTS ARE DIMENSIONED FROM TOP OF FINISH FLOOR (A.F.F.), UNLESS OTHERWISE NOTED.
- 16 SIEMENS FIRE LIFE SAFETY DEVICES AND CONNECTIONS TO BE USED.

- PREMISES AND SHALL BASE HIS BID ON THE EXISTING CONDITIONS, NOTWITHSTANDING ANY INFORMATION SHOWN OR NOT SHOWN ON THE CONSTRUCTION DRAWINGS. ARRANGEMENTS TO VISIT THE PREMISES SHOULD BE MADE WITH THE BUILDING MANAGEMENT.
  - EXISTING MATERIALS AND ALL FINISHES FROM DAMAGE WHICH MAY OCCUR FROM CONSTRUCTION, DEMOLITION, DUST, WATER, ETC. AND SHALL PROVIDE AND MAINTAIN TEMPORARY BARRICADES, ETC., AS REQUIRED TO PROTECT THE PUBLIC DURING THE PERIOD OF CONSTRUCTION. DAMAGE TO NEW AND/OR EXISTING MATERIALS, FINISHES, STRUCTURES AND EQUIPMENT SHALL BE REPAIRED OR REPLACED TO THE SATISFACTION OF THE TENANT AT THE EXPENSE OF THE GENERAL CONTRACTOR.
- IN ADEQUATE TIME TO ALLOW FOR REVIEW AND APPROVAL BY THE ARCHITECT AND FOR THE MATERIALS/EQUIPMENT, THE ARCHITECTURAL DRAWINGS POSSIBILITY OF HAVING THE SUBSTITUTION REJECTED SHALL GOVERN AND THE GENERAL CONTRACTOR SHALL AND THUS NEEDING TO PROVIDE THE ORIGINAL 20 CONTRACTOR SHALL COORDINATE WITH TENANT/OWNER
  - 35 ALL CONSTRUCTION WORK, ARCHITECTURAL, MECHANICAL, ELECTRICAL, ETC., SHALL CONFORM TO ALL GOVERNING BUILDING CODES AND REGULATIONS ALL FINISH MATERIALS MUST MEET ALL APPLICABLE
- CONSTRUCTION DOCUMENTS SHALL BE SUPPLIED AND 9 ALL SURFACES SHALL BE IN PROPER CONDITION TO HOURS BASIS TO BE COORDINATED WITH THE BUILDING INSTALLED BY THE GENERAL CONTRACTOR EXCEPT WHERE NOTED OTHERWISE. THE GENERAL CONTRACTOR SHALL CLOSELY COORDINATE HIS WORK WITH THAT OF OTHER CONTRACTORS. SUBCONTRACTORS AND/OR VENDORS TO ASSURE THAT ALL SCHEDULES ARE MET AND THAT ALL WORK IS DONE IN CONFORMANCE TO MANUFACTURER'S REQUIREMENTS.
  - 37 THE GENERAL CONTRACTOR SHALL SUBMIT SHOP DRAWINGS (2 SET OF PRINTS) FOR FABRICATED ITEMS. CUTS OF ALL FIXTURES AND EQUIPMENT, AND SAMPLES OF ALL FINISHES CALLED FOR TO THE ARCHITECT FOR APPROVAL PRIOR TO FABRICATION/PURCHASING, ETC. PROVIDE ENOUGH CUT SHEETS AND/OR SAMPLES SO THAT THE ARCHITECT CAN RETAIN (2) FOR RECORD AND DISTRIBUTION. THIS APPLIES TO ALL ABOVE STANDARD ELEMENTS ONLY.
  - THE GENERAL CONTRACTOR SHALL BE REQUIRED TO APPROVED (OR EQUIVALENT AS ACCEPTED BY THE BUILDING DEPARTMENT). LABEL CERTIFICATES TO THE 13 PRIOR TO PURCHASE OR INSTALLATION OF ANY FINISH 13 BUILDING DEPARTMENT WHEN AND WHERE REQUESTED BY THE BUILDING DEPARTMENT.
  - THE GENERAL CONTRACTOR SHALL MAINTAIN A 39 CURRENT AND COMPLETE SET OF CONSTRUCTION DOCUMENTS ON THE JOBSITE DURING ALL PHASES OF 14 CONTRACTOR SHALL SUPPLY 5% OVER ENTIRE SQUARE CONSTRUCTION FOR THE USE OF ALL TRADES AND SHALL PROVIDE ALL SUBCONTRACTORS WITH CURRENT CONSTRUCTION DOCUMENTS. THE GC IS TO PROVIDE A SET OF AS-BUILT DOCUMENTS TO THE TENANT AND 15 ALL NEW AND EXISTING FINISHES SCHEDULED TO REMAIN
  - THE GENERAL CONTRACTOR SHALL REMOVE ALL 40 RUBBISH AND WASTE MATERIALS OF ALL SUBCONTRACTORS AND TRADES ON A DAILY BASIS AND SHALL EXERCISE STRICT CONTROL OVER JOB CLEANING TO PREVENT ANY DIRT, DEBRIS OR DUST FROM AFFECTING THE WORK OR COMMON AREAS OF JOBSITE, THE BUILDING REFUSE FACILITIES SHALL NOT BE USED FOR THIS PURPOSE.
  - UPON COMPLETING THE JOB, THE CONTRACTOR SHALL CLEAN AND IN AN ORDERLY MANNER READY FOR MOVE-IN. THIS IS TO INCLUDE CLEANING OF ALL GLASS (INCLUDING INSIDE OF EXTERIOR GLASS) AND FRAMES, BOTH NEW AND EXISTING.
  - RESOLUTION OF ALL QUESTIONS OR VARIANCES MUST 42 BE MADE THROUGH THE ARCHITECT AND CONFIRMED IN
- REPETITIVE FEATURES NOT NOTED ON DRAWING SHALL ANY DAMAGE THAT OCCURS SHALL BE THE FINANCIAL 43 BE COMPLETELY PROVIDED AS IF DRAWN IN FULL.
- PUNCH LIST REVIEW IMMEDIATELY PRIOR TO 44 MOVE-IN, CONTRACTOR WILL SUBMIT HIS PUNCH LIST 29 EQUIPMENT SHALL BE APPLIED, INSTALLED, CONNECTED, (PER AIA CONTRACT A201, SECTION 9.8.2) TO TENANT ARCHITECT AND BUILDING REPRESENTATIVE FOR A WALK THROUGH AT THE SITE.

- 32 CONTRACTOR SHALL THOROUGHLY EXAMINE THE
- 33 CONTRACTOR SHALL PROTECT THE AREA, NEW AND/OR 2 UNLESS OTHERWISE NOTED PROVIDE MINIMUM 3-COAT 3 ALL WALL PAINT SHALL BE LATEX, EGGSHELL FINISH,
- 34 ANY REQUEST FOR SUBSTITUTION SHALL BE SUBMITTED 5 TRANSPARENT FINISHED WOOD DOORS, ARCHITECTURAL SPECIFIED ITEM. ITEMS SHALL NOT BE PURCHASED OR FREE OF SEALERS, CURING COMPOUNDS, OIL, DIRT AND INSTALLED WITHOUT PRIOR WRITTEN APPROVAL OF THE
- FIRE, LIFE SAFETY AND BUILDING CODES.
- 36 ALL WORK LISTED, SHOWN OR IMPLIED, ON ANY
- 38 SUBMIT ALL SMOKE DENSITY AND FLAME SPREAD U.L.
- THE BUILDING IN ANY FINISHED AREAS IN OR OUTSIDE
- 41 LEAVE THE PREMISES AND ALL AFFECTED AREAS
- WRITTEN FORM.

ENSURE THAT SURFACES THAT ARE TO RECEIVE FINISHES ARE CLEAN, TRUE, AND FREE OF IRREGULARITIES. DO NOT PROCEED WITH WORK UNTIL UNSATISFACTORY CONDITIONS HAVE BEEN CORRECTED. STARTING OF WORK SHALL INDICATE INSTALLER'S ACCEPTANCE OF SUBSTRATE.

7 WHERE MORE THAN ONE (1) SHEET VINYL COLOR HAS

ARCHITECT FOR REVIEW AND APPROVAL PRIOR TO

METAL SHALL BE HAND SAND PAPERED AND DUSTED

CLEAN. ALL KNOT HOLES, PITCH POCKETS OR SAPPY

8 CARPET SEAMING DIAGRAM TO BE SUBMITTED TO

ANY OIL OR GREASE WITH MINERAL SPIRITS.

10 INTERIOR GYPSUM WALLBOARD SURFACES SHALL BE

WHICH MAY HAVE FORMED IN SANDING PROCESS.

1 ELECTRICAL SWITCH AND OUTLET COVER PLATES,

12 THE CONTRACTOR SHALL, UPON COMPLETION, REMOVE

SPLATTERED ON EXPOSED ADJACENT SURFACES.

TENANT FOR FUTURE PATCHING STOCK.

SHALL BE PROTECTED DURING CONSTRUCTION. ANY

STRUCTURAL STEEL COLUMNS, BRACING AND SEISMIC

WILL BE MADE WITHIN SIX WEEKS OF THE SCHEDULED

ANY PROBLEMS REGARDING AVAILABILITY OF FINISH

MATERIALS ARE TO BE BROUGHT TO THE ARCHITECT'S

FITTINGS, ETC. SHALL RECEIVE ONE COAT METAL

AT HIS COST WITH NO COST TO OWNER AND/OR

16 ALL METAL SURFACES SUCH AS ACCESS DOORS

ALL PAINT FROM WHERE IT HAS SPILLED, SPLASHED OR

OF THE FIRST COAT, IN ORDER TO LAY FLAT ANY NAP

BEEN PROVIDED FOR FLOORING, CONTRACTOR TO REFER

FINISH NOTES:

FINISH PAINT.

TO LAYOUT, U.O.N.

PLACING ORDER.

REQUIRED.

SCHEDULE.

ATTENTION IMMEDIATELY.

- ONE- PIECE TYPE, U.O.N. PAINT SYSTEMS AS SPECIFIED FOR EACH SUBSTRATE; REFER TO FINISH SCHEDULE FOR COLORS AND SHEENS.
- U.O.N. PAINT SYSTEM: ONE COAT PRIMER 2 COATS TREATMENT.
- 4 REPAIR AND PREPARE EXISTING SURFACES SHOWN TO 4 VERIFY ALL EQUIPMENT MOUNTING REQUIREMENTS OF REMAIN AS REQUIRED FOR APPLICATION OF NEW
- WOODWORK, AND CABINETRY SHALL BE SHOP FINISHED,
- 6 THE FLOOR UNDER THE CARPETED AREAS MUST BE 6 COORDINATE INSTALLATION OF TELEPHONE AND
  - ARCHITECTURAL DRAWINGS ARE SCHEMATIC IN NATURE. ALL APPLICABLE CODES. FOR PROPER SIZING AND CIRCUITING OF WORK.
  - 8 REMOVE ALL FLOOR MONUMENTS PRIOR TO CARPET INSTALLATION. REMOVE COVER PLATES FROM ALL ARE TO BE FLUSH WITH FLOOR SURFACE.
- RECEIVE THE SPECIFIED FINISH. PAINT GRADE WOOD. OR PORTIONS SHALL BE SCRAPED AND FITTED, OR SEALED WITH SEALER, NAIL HOLES, CRACKS OR DEFECTS SHALL BE CAREFULLY PUTTIED AFTER FIRST COAT WITH PUTTY WITH PANEL AND BREAKER NUMBER. MATCHING COLOR OF STAIN OR PAINT FINISH. REMOVE
- AND INSTALLATION REQUIREMENTS FROM TENANT TO WIPED WITH A DAMP CLOTH JUST PRIOR TO APPLICATION ENSURE PROPER REQUIREMENTS ARE MET.
- OTHER ORDINANCES OF CITY, STATE AND FEDERAL SURFACE HARDWARE, ETC. SHALL BE INSTALLED AFTER
  - 12 ALL ELECTRICAL MATERIALS AND EQUIPMENT SHALL BE LISTED BY UNDERWRITERS LABORATORIES.
- ALL FLOOR PENETRATIONS SHALL BE FIREPROOFED AS REQUIRED BY CODE. MATERIALS SUBMIT SAMPLES TO ARCHITECT FOR REVIEW
- IN CONFORMANCE WITH SPECIFIED PROCEDURES. ALLOW SUBCONTRACTOR SHALL FURNISH AND INSTALL TIME FOR SUBMITTAL REVIEW AND FOR RESUBMITTALS IF SYSTEM. ALL MATERIALS SHALL BE NEW AND FREE FROM DEFECTS.
  - CONTRACTOR TO VERIFY SPECIAL CONSTRUCTION REQUIRING SPECIAL OUTLETS, SWITCHES OR MOUNTING ON ONE HOUR FIRE RATED WALLS.
- DAMAGE SHALL BE REPAIRED BY CONTRACTOR INVOLVED 10 NOTIFY THE ARCHITECT IMMEDIATELY FOR RESOLUTION 9 CONFLICTS WITH SUSPENDED GRID SYSTEM OR HVAC, DRAWINGS, M.E.P. DRAWINGS AND FIELD CONDITIONS.
- ARE RESPONSIBLE FOR ALL INFORMATION ON ARCHITECTURAL DRAWINGS. PRIMER AND 2 COATS ALKYD BASED PAINT. COLOR TO 17
- 17 IT IS THE CONTRACTOR'S RESPONSIBILITY TO CONFIRM THE AVAILABILITY AND DELIVERY DATES OF ALL FINISH BE IN STRICT ACCORDANCE WITH ALL BUILDING MATERIALS. NO SUBSTITUTIONS OF FINISH MATERIALS DEPARTMENT AND FIRE DEPARTMENT CODES AND ORDINANCES AS WELL AS TITLE 24 ENERGY COMPLETION DATE. ALL FINISH MATERIALS WILL BE ON REQUIREMENTS. SITE AT LEAST TWO WEEKS PRIOR TO INSTALLATION. 18
  - TELEPHONE, ELECTRICAL, ETC. U.O.N.
- 18 THE CONTRACTOR SHALL EXAMINE ALL FINISH SURFACES 20
- AFTER COMPLETION OF WORK ( INCLUDING TELEPHONE INSTALLATION & CARPET) AND PROCEED WITH
- 19 THE CONTRACTOR SHALL MODIFY EXISTING FLOOR SURFACES AS REQUIRED TO INSTALL NEW FLOORING MATERIALS THUS PREVENTING NOTICEABLE LUMPS, OR DEPRESSIONS WHICH MAY CAUSE UNUSUAL WEAR TO NEW MATERIALS.
- 20 PAINT ALL ACCESS PLATES & PANEL BOXES TO MATCH ADJACENT PAINTED SURFACES.
- 21 PROVIDE AN "H" CUT AT CARPET ALL OPEN POWER AND DATA FLOOR MONUMENTS.

FREE OF ALL FOREIGN MATERIAL, SANDED AND

- REFINISHED TO RECEIVE BUILDING STANDARD FINISH. 25 23 THE CONTRACTOR SHALL SUBMIT 8-1/2" X 11" BRUSHOUTS AND/OR SAMPLES OF ALL FINISH TYPES 26 AND COLORS TO THE ARCHITECT FOR APPROVAL PRIOR TO PROCEEDING WITH INSTALLATION AND/OR
- 24 ALL FINISH MATERIALS MUST MEET ALL APPLICABLE FIRE, LIFE SAFETY, AND BUILDING CODES.

APPLICATION.

- 25 CAULKS, SEALANTS, ADHESIVES, PAINTS, STAINS, AEROSOLS, AND CAOTINGS WILL BE COMPLIANT WITH LIMITS FOR VOC AND OTHER COMPOUNDS AS PER CALGREEN SECTION 5.504.4.
- 26 PROTECT CARPET AND REPLACE AS NEEDED.

### POWER / DATA NOTES:

- 1 SEE MECHANICAL AND ELECTRICAL DRAWINGS FOR ADDITIONAL NOTES AND INFORMATION. WHERE CONFLICTS OCCUR, ARCHITECTURAL DRAWINGS SHALL TAKE PRECEDENCE FOR LOCATION.
- 2 INDICATED DIMENSIONS ARE TO THE CENTERLINE OF THE OUTLET OR CLUSTER OF OUTLETS. UNLESS OTHERWISE NOTED; GANG COVER PLATES SHALL BE
- DO NOT MOUNT OUTLETS BACK-TO-BACK ON OPPOSITE SIDES OF PARTITION; MAINTAIN MINIMUM 3 INCH SEPARATION AND PACK OUTLETS WITH ACOUSTIC
- ALL ELECTRICAL, TELEPHONE AND OTHER EQUIPMENT.
- 5 ALL CORING LOCATIONS SHALL BE REVIEWED IN FIELD BY ARCHITECT AND COORDINATED WITH BUILDING MANAGER, FURNITURE DEALER AND TENANT PRIOR TO
- SECURITY SYSTEMS UNLESS OTHERWISE NOTED.
- ELECTRICAL CONTRACTOR SHALL BE RESPONSIBLE FOR VERIFYING ALL EXISTING CONDITIONS, COMPLYING WITH
- PREVIOUSLY CAPPED OUTLETS. ALL CAPPED OUTLETS
- ALL NEW DEDICATED OUTLETS SHALL BE IDENTIFIED BY THE LETTER "D". THE HALF OF EACH FOURPLEX OUTLET THAT IS TO BE ON A DEDICATED CIRCUIT SHALL BE IDENTIFIED BY A "D". ALL DEDICATED OUTLETS TO BE COLORED ORANGE. INCLUDE OUTLET ID
- 10 OBTAIN EQUIPMENT SPECIFICATIONS, INCLUDING POWER
- ALL ELECTRICAL WORK SHALL CONFORM TO CURRENTLY 11 ADOPTED U.B.C. WITH SAN MATEO AMENDMENTS AND
- ELECTRICAL MECHANICAL & PLUMBING DESIGN/BUILD
- COMPLETE, ALL MATERIALS, EQUIPMENT AND LABOR, AS 7 SHOWN AND AS NECESSARY FOR COMPLETE WORKABLE FOOTAGE OF CARPET AND RESILIENT FLOORING TO 14
  - OF ANY DISCREPANCIES BETWEEN THE ARCHITECTURAL
  - ELECTRICAL MECHANICAL AND PLUMBING CONTRACTORS 10 LAYOUT OF CEILING FIXTURES WITHOUT REVIEW AND
- MATCH ADJ. SURFACES OR AS SPECIFIED IN THE FINISH GENERAL CONTRACTOR IS TO COORDINATE ALL SUB 11 ARE FOR NEW DESIGN AND CONSTRUCTION ALL CEILING CONTRACTORS FOR COMMUNICATIONS\DATA TO VERIFY REQUIREMENTS AND TO SCHEDULE PULLING OF CABLES. ALL ELECTRICAL AND TELEPHONE INSTALLATION SHALL
  - EACH CONDUIT TO RECEIVE ONLY ONE TYPE OF CABLE;
  - LOCATE SWITCHES AT +44" A.F.F., U.O.N.
  - ALL OUTLETS TO BE MOUNTED 18" AFF, U.O.N. ALL WALL OUTLETS ARE TO BE MOUNTED VERTICALLY, U.O.N. ANY ELECTRICAL WALL OUTLET HIGHER THAN
  - A MINIMUM OF 2" CLEAR MUST BE MAINTAINED FOR ANY FLOOR OUTLET ADJACENT TO A WALL, U.O.N.

18" SHALL BE MOUNTED HORIZONTALLY-U.O.N.

- ELECTRICAL CONTRACTOR SHALL VERIFY AND COORDINATE CONDUIT RUNS, CIRCUITING, AND WIRING AS REQUIRED TO PROVIDE COMPLETE ELECTRICAL INSTALLATION. AS-BUILT RECORDS OF CIRCUIT AND WIRING SHALL BE PREPARED AT THE COMPLETION OF THE PROJECT.
- 22 ALL (E) AND/OR RELOCATED DOORS SHALL BE CLEANED ALL OUTLETS AT OR ABOVE COUNTERS WITHIN 6'-0" OF A SINK SHALL BE GFI TYPE.
  - ELECTRICAL CONTRACTOR TO PROVIDE TEMPORARY LIGHTING THROUGHOUT AREA OF WORK.

PENETRATIONS THROUGH BLOCKING AT BEAM

ABOVE.

LOCATIONS MAY BE PERMITTED SUBJECT TO NOTE 6

ALL ELECTRICAL WIRING IN EXPOSED CEILING, WALL AND

OR CEILING LOCATIONS SHALL UTILIZE THIN WALL MOUNTING HEIGHTS FOR THERMOSTATS SHALL BE 44" METAL CONDUIT (EMT) OR AS REQUIRED BY CODE. THE USE OF FLEXIBLE METAL CONDUIT RUNS IN EXPOSED CEILING AREAS SHALL BE POSITIONED AND SECURED SO AS TO BE AS INCONSPICUOUS AS POSSIBLE. DIAGONAL RUNS ACROSS THE UNDERSIDE AT 44" A.F.F. OF THE CEILING FRAMING SHALL NOT BE PERMITTED. WHERE CONDUIT RUNS PERPENDICULAR TO JOISTS, RUNS SHALL BE LOCATED ADJACENT TO BEAMS WHERE CONDUIT RUNS PARALLEL TO JOISTS, RUNS SHOULD BE

- 29 TELEPHONE AND DATA CABLE TO BE CATEGORY 5 CABLE. ALL PORTS TO HAVE REDUNDANT WIRING U.O.N. TELEPHONE AND DATA CABLE TO BE DISTINGUISHED BY COLOR.
- 30 ALL OUTLETS, SWITCHES, AND COVERPLATES TO BE WHITE U.O.N.
- 31 ADD GE LIGHTING CONTROL INTERFACE. ALL LIGHTS TO 2 ALL PARTITIONS ARE DIMENSIONED FROM FINISH FACE BE INTEGRATED WITH BUILDING GE LIGHTING CONTROLS.
- 32 ALL ELECTRICAL AND TELEPHONE INSTALLATION SHALL BE IN STRICT ACCORDANCE WITH ALL BUILDING DEPARTMENT AND FIRE DEPARTMENT CODES AND ORDINANCES AS WELL AS TITLE 24 ENERGY REQUIREMENTS
- CEILING NOTES:
- REFER TO MECHANICAL, ELECTRICAL AND PLUMBING DRAWINGS AND SPECIFICATIONS FOR DESIGN OF THESE SYSTEMS (DUCT SIZES, CIRCUITING, ETC.). HOWEVER, LOCATIONS OF FIXTURES, SWITCHES, ETC. SHALL BE AS 5 CONTRACTOR SHALL CHALK LOCATIONS OF PARTITIONS SHOWN ON ARCHITECTURAL PLANS AND ELEVATIONS. NOTIFY ARCHITECT OF ANY CONFLICTS PRIOR TO COMMENCING CONSTRUCTION.
- VERIFY FIELD CONDITIONS AND LOCATIONS OF ALL PLUMBING, DUCTS, STRUCTURAL ELEMENTS, AND OTHER 6 AT ACOUSTICAL PARTITIONS, STAGGER ALL JOINTS IN APPLICABLE ITEMS. ARRANGE AND MODIFY NON-VISIBLE ITEMS TO INSURE ADEQUATE CLEARANCES FOR CEILING LAYOUT AS SHOWN.
- 3 IN AREAS WITH ACOUSTICAL CEILING TILE, ALL REGISTERS AND LIGHTING FIXTURES SHALL OCCUR WITHIN GRID LINES AND SPRINKLER HEADS (WHERE APPLICABLE), INCANDESCENT FIXTURES, OR OTHER CEILING ELEMENTS SHALL BE LOCATED ON THE CENTERLINE OF ACOUSTICAL UNITS, U.O.N.
- 4 G.C. TO COORDINATE WITH BUILDING OWNER ANY ACCESS ISSUES WITH REGARDS TO BASE BUILDING HVAC, ELECTRICAL, PLUMBING, AND LIFE SAFETY THAT MUST REMAIN UNOBSTRUCTED AND/OR REASONABLY ACCESSIBLE FOLLOWING TENANT MOVE IN.
- CEILING FIXTURES ARE LOCATED IN ACCORDANCE WITH CEILING GRID SHOWN ON THE RCP. IF INSTALLED CEILING GRID DIFFERS FROM WHAT IS SHOWN ON THIS DRAWING, CONTRACTOR IS RESPONSIBLE FOR COORDINATING WITH ARCHITECT THE FIXTURE LOCATIONS WITHIN THOSE SPACES. UNAPPROVED WORK IS SUBJECT TO REINSTALLATION WITHOUT ADDITIONAL COST TO THE PROJECT.
- QUANTITY AND APPROXIMATE LOCATIONS OF THERMOSTATS SHALL BE DETERMINED BY M.E.P. DESIGN BRACED AS REQUIRED BY CODE. SEE DETAILS. BUILD CONTRACTOR. LOCATIONS SHALL BE SUBMITTED TO ARCHITECT FOR REVIEW & APPROVAL PRIOR TO INSTALLATION.
- LIGHT SWITCHING SHALL CONFORM TO TITLE 24 REQUIREMENTS. DOUBLE SWITCH WITH EACH SWITCH CONTROLLING 50% OF LAMPS PER FIXTURE ALL ROOMS/AREAS OF GREATER THAN 100 SQ. FT.
- 8 NOT USED
- CONTRACTOR SHALL NOTIFY ARCHITECT OF ANY PLUMBING, LIFE SAFETY, ETC. PRIOR TO INSTALLATION. 12 ALL WORK SHALL BE INSTALLED AS SHOWN ON
- APPROVAL BY THE ARCHITECT.

ABSOLUTELY NO CHANGES ARE TO BE MADE TO

- WHERE THE ACOUSTIC CEILING TILES AND GRID SYSTEM TILES INSTALLED SHALL BE NEW MATERIAL AND FREE FROM DEFECTS AND ANY CAULKING MATERIAL.
- ELECTRICAL CONTRACTOR SHALL FIELD CHECK THE 12 PREMISES AND VERIFY ALL CLEARANCES AS REQUIRED FOR ANY AND ALL LIGHTING FIXTURES BEFORE PROCEEDING WITH ANY INSTALLATION. REPORT ANY DISCREPANCIES TO ARCHITECT OR TENANT REPRESENTATIVE FOR RESOLUTION BEFORE ANY FIXTURES ARE INSTALLED ARCHITECT RESERVES THE RIGHT TO RELOCATE FIXTURES SHOWN ON PLAN TO DOES NOT POINT OUT DISCREPANCY BEFORE ANY
- ELECTRICAL, MECHANICAL AND PLUMBING CONTRACTORS 17 13 MUST COORDINATE INSTALLATION AND REQUIRED CLEARANCES OF THEIR EQUIPMENT

FIXTURES ARE INSTALLED.

- THE CONTRACTOR SHALL VERIFY ALL FIELD CONDITIONS 18 ALL DOORS DESIGNATED TO BE FIRE—RATED SHALL BE 14 AND DIMENSIONS AND SHALL BE RESPONSIBLE FOR ACHIEVING THE NECESSARY CLEARANCES FOR ALL SPECIFIED ITEMS ON THE DRAWINGS.
- MECHANICAL, ELECTRICAL AND PLUMBING DESIGN-BUILD DRAWINGS RESPONSIBLE FOR SPECIFICATIONS FOR LAYOUTS OF AND EQUIPMENT AND DESIGN OF THESE RESPECTIVE SYSTEMS INFORMATION INCLUDING BUT NOT LIMITED TO LIGHTING, WIRING, SWITCHING AND HVAC. 20
- ALL WIRING FOR LIGHT FIXTURES, EXIT SIGNS OR OTHER 16 ELECTRICAL DEVICES SHALL BE U.L. APPROVED AND INSTALLED IN ACCORDANCE WITH APPROPRIATE CODES. 21
- ALL CEILING FIXTURES SHALL BE CERTIFIED U.L. 17 APPROVED PRIOR TO INSTALLATION.
- 18 A.F.F. U.O.N. LIGHT SWITCHES LOCATED ON WALL PERPENDICULAR TO 19 DOOR SHALL BE 39" CENTERLINE FROM FACE OF DOOR
- WHERE SWITCHES ARE SHOWN ADJACENT TO EACH 20 OTHER, THEY SHALL BE GANGED AND COVERED BY A SINGLE PLATE, U.O.N. LOCATED AND MOUNTED TO THE SIDES OF THE JOISTS.

- PARTITION NOTES:
- 1 DO NOT SCALE DRAWINGS. WRITTEN DIMENSIONS GOVERN. ALL PARTITION LOCATIONS, DIMENSIONS AND TYPES, ALL DOOR AND WINDOW LOCATIONS SHALL BE AS SHOWN ON CONSTRUCTION PLAN. IN CASE OF CONFLICT, NOTIFY ARCHITECT IMMEDIATELY. CONSTRUCTION PLAN BY ARCHITECT SUPERSEDES ALL OTHER PLANS.

26 ALIGN NEW PARTITION SURFACES WITH THE (E)

27 COORDINATE LOCATIONS AND PROVIDE ADEQUATE

BLOCKING WITHIN PARTITIONS FOR ALL CABINETS,

DIMENSIONS FOR ACCURACY AND COORDINATION

COUNTERS, SHELVES AND ANY WALL MOUNTED ITEMS.

BEFORE PROCEEDING WITH CONSTRUCTION. IF THERE

COORDINATION QUESTIONS, OBTAIN A CLARIFICATION

ARE ANY QUESTIONS REGARDING THESE OR ANY OTHER

FROM THE ARCHITECT BEFORE PROCEEDING WITH WORK

PARTITIONS SHALL BE NON- TEXTURED, SMOOTH WALL

OR ADJOINING SURFACES.

IN QUESTION OR RELATED WORK.

FINISH U.O.N.

29 ALL NEWLY INSTALLED GYPSUM WALL BOARD

ADJACENT OR ADJOINING SURFACES. TAPE AND SAND

THE JOINTS SMOOTH WITHOUT ANY VISIBLE JOINTS.

PATCH AND REPAIR SURFACES TO MATCH ADJACENT

- TO FINISH FACE, UNLESS OTHERWISE NOTED. ALL DIMENSIONS MARKED "CLEAR" SHALL BE MAINTAINED 28 CHECK CONTRACT DOCUMENTS, FIELD CONDITIONS AND AND SHALL ALLOW FOR THICKNESS OF ALL FINISHES INCLUDING CARPET (AND CUSHION), CERAMIC TILE, VCT,
- 3 DIMENSIONS LOCATING DOORS BY EDGE ARE TO THE INSIDE EDGE OF JAMB, UNLESS OTHERWISE NOTED.
- FOR DIMENSIONING ONLY, VERIFY EXACT LOCATIONS IN

AND DOORS ON FLOOR FOR REVIEW BY ARCHITECT

PRIOR TO INSTALLATION. REVIEW WILL BE FOR DESIGN

INTENT, CONTRACTOR SHALL COORDINATE AND VERIFY

COLUMN CENTER LINES (OR GRID LINES) ARE SHOWN

ALL CONDITIONS TO ENSURE PROPER FIT. GYPSUM BOARD AND PROVIDE LOW DENSITY ACOUSTICAL BATT INSULATION: FOUR POUNDS PER CUBIC INCH. 2-1/2" THICK, UNFACED FIBERGLASS INSULATION OWENS-CORNING NOISE BARRIER, USG

THERMAFIBER OR APPROVED EQUAL. WHERE BATT

INSULATION IS INDICATED.

- 7 VERIFY ALL DIMENSION SHOWN ON DRAWINGS BY TAKING FIELD MEASUREMENTS; PROPER FIT AND ATTACHMENT OF ALL PARTS ARE REQUIRED. BEFORE COMMENCING WORK, CHECK ALL LINES AND LEVELS INDICATED AND OTHER SUCH WORK AS HAS BEEN COMPLETED. SHOULD THERE BE ANY DISCREPANCIES, REPORT IMMEDIATELY TO THE ARCHITECT FOR CORRECTION OR ADJUSTMENT. IN EVENT OF FAILURE TO DO SO, THE CONTRACTOR SHALL BE RESPONSIBLE FOR CORRECTION OF ANY ERRORS.
- 8 CONTRACTOR SHALL COORDINATE ALL WORK WITH MECHANICAL ELECTRICAL AND PLUMBING DESIGN BUILD SUB CONTRACTORS AND REPORT IMMEDIATELY TO THE ARCHITECT ANY DISCREPANCIES FOR CORRECTION OR ADJUSTMENT. NO ALLOWANCE WILL BE MADE FOR INCREASED COSTS INCURRED DUE TO LACK OF PROPER COORDINATION.
- 9 ALL PARTITIONS SHALL BE ANCHORED FIRMLY AND
- 10 ALL GLAZING SHALL MEET REQUIREMENTS OF GOVERNMENTAL CODES AND ORDINANCES, AND MEET DESIGN STRESS REQUIREMENTS FOR SIZE. SUBMIT SAMPLES OF GLASS TO ARCHITECT FOR REVIEW PRIOR TO ORDERING, FOR ABOVE STANDARD DETAILS ONLY.
- 11 CONTRACTOR WILL INSPECT AND LEVEL FLOOR WHERE REQUIRED, AND INSTALL "LEVELING" UNDERLAYMENT AT VCT, WOOD FLOORS AND BUILT-IN FILE LOCATIONS TO ASSURE LEVEL SURFACE AND ALIGNMENT WITH ADJACENT CARPET AND/ OR PAD, UNLESS OTHERWISE
- DRAWINGS PLUMB, LEVEL, TRUE TO LINE AND SECURELY FASTENED OR ANCHORED.
- 13 ALL MILLWORK SHALL CONFORM TO THE STANDARDS OF THE W.I.C. FOR QUALITY AND CRAFTMANSHIP. STANDARD CLASSIFICATIONS: P. LAM. -W.I.C. CUSTOM. CUSTOM WD. - W.I.C. PREMIUM.
- 15 CONTRACTOR SHALL INSTALL DOORS COMPLETE WITH ALL HARDWARE FITTINGS AND ACCESSORIES AS REQUIRED FOR SPECIFIC INSTALLATION AND FURNISH ANY SPECIAL ITEMS REQUIRED FOR CODE CONFORMANCE (SUCH AS ADA) AT EVERY DOOR LOCATION. SPECIFY SCHLAGE HARDWARE TO MATCH
- INSURE PROPER DISTRIBUTION OF LIGHT IF CONTRACTOR 16 ALL DOORS TO BE UNDERCUT 1/4" OVER CARPET AND VINYL TILE (EXCEPT FIRE-RATED DOORS) AT FINISH
  - ALL LABELED (FIRE RATED) DOORS SHALL BE INSTALLED WITH MINIMUM CLEARANCE ABOVE

LABELED AS REQUIRED BY CODE.

- THRESHOLD OR ABOVE FINISH FLOOR.
- 19 THE FINISH HARDWARE SUPPLIER SHALL EXAMINE THE DRAWINGS, SCHEDULES, AND SPECIFICATIONS AND FURNISH PROPER HARDWARE WHETHER LISTED OR NOT. HE SHALL ALSO SUPPLY A COMPLETE HARDWARE LIST AND SCHEDULE TO THE ARCHITECT FOR REVIEW.
- ALL HARDWARE SHALL BE INSTALLED ACCORDING TO THE STANDARDS OF THE SPECIFIC MANUFACTURERS
- ALL FRAMES TO HAVE DOOR SILENCERS.
- 22 REFER TO DOOR SCHEDULE, DOOR TYPES AND FINISH HARDWARE GROUPS FOR SPECIFIC DOOR REQUIREMENTS.
- 23 ALL PERMANENT AND TEMPORARY BLOCKING, HARDWARE, AND ALL OTHER MISCELLANEOUS MATERIAL, TOOLS, AND TECHNIQUES IMPLIED BY THE DRAWINGS SHALL BE INCLUDED IN THIS WORK SO AS TO PRODUCE A COMPLETE AND FINISHED PRODUCT
- 24 ALL INTERIOR OPEN JOINTS, PENETRATIONS AND OTHER OPENINGS SHALL BE SEALED, CAULKED, GASKETED OR WEATHER-STRIPPED TO LIMIT AIR LEAKS.
- 25 WHERE GYPSUM WALL BOARD MEETS EXISTING CORNER, REMOVE (E) METAL CORNER BEAD PRIOR TO INSTALLATION OF NEW GYPSUM WALLBOARD.

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### Project: Media Services Relocation 200 McAllister Street San Francisco, CA

Project Number: 491-142



**UC Hastings College of Law** 200 McAllister Street San Francisco, CA

Rev. Issue Date 1.9.14 BID SET

Scale: N/A


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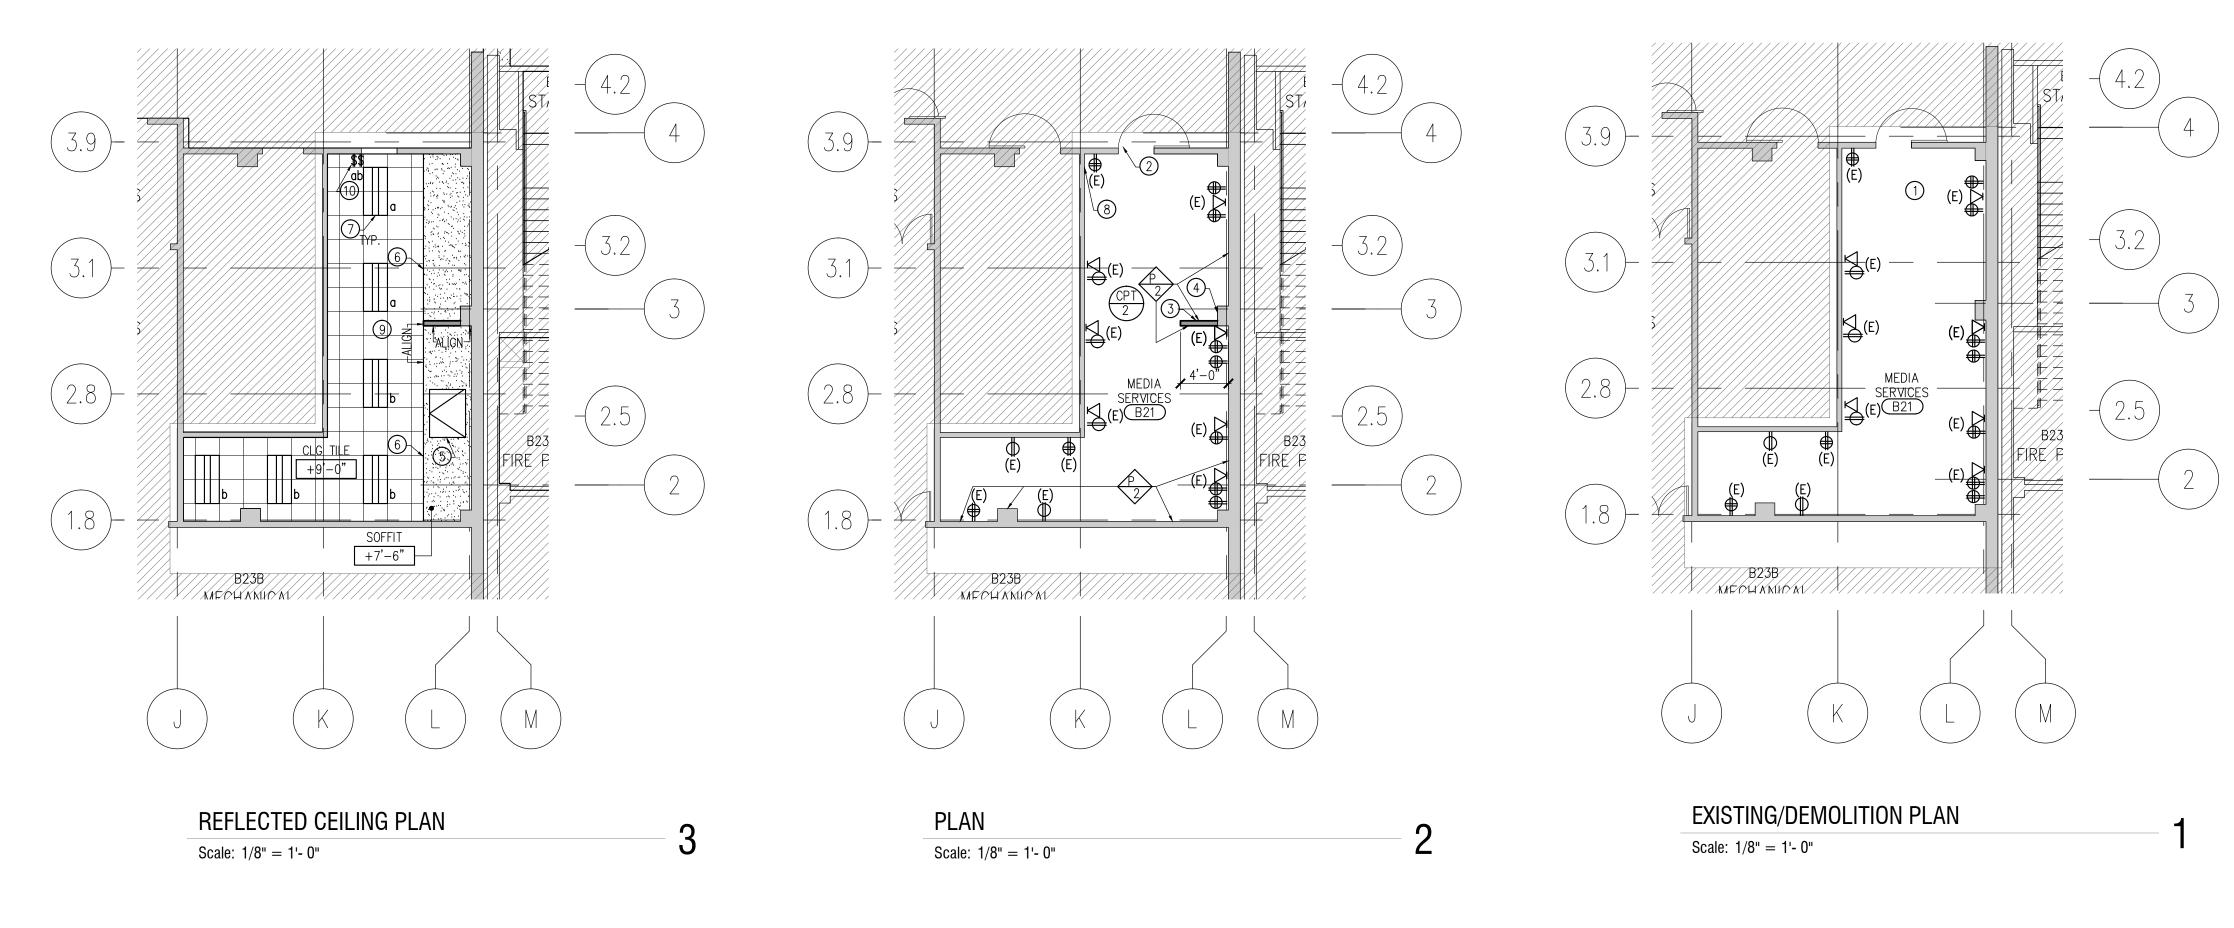
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**GENERAL NOTES** 

Checked By: --Drawn By: --

Sheet Number:



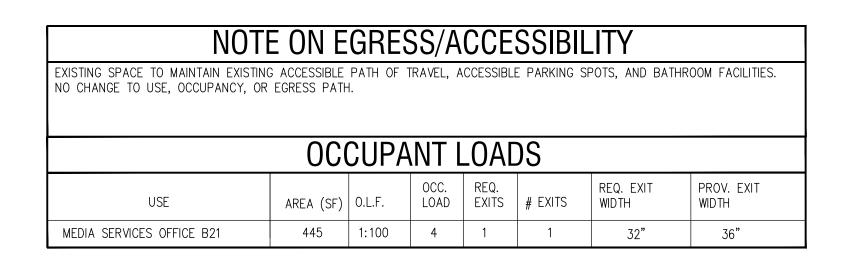

### PLAN KEYNOTES **GENERAL NOTES** LEGEND CUT IN NEW FIRE EXTINGUISHER CABINET, TOP OF CABINET TO BE 60" AFF. ALTA 7063-DV SEMI-RECESSED, STAINLESS STEEL, VERTICAL BLACK LETTERING (1) REMOVE EXISTING CARPET. REMOVE ALL EXISTING LIGHTS. RETURN TO OWNER. ALLOW FOR PATCHING OF EXISTING WALLS AS NEEDED. EXISTING INTERIOR & EXTERIOR WALL ARMSTRONG CEILING SYSTEM (2) EXISTING DOOR TO REMAIN. PAINT WALLS P-1 UNLESS OTHERWISE NOTED. SEE FINISH SCHEDULE, 3/A1.5. 24"x 24" SQUARE TEGULAR TILES, MATCH BUILDING STANDARD. 4. SAVE REGISTERS, FIRE ALARM DEVICES FOR REUSE. RETURN UNUSED MATERIALS TO OWNER. NEW FULL HEIGHT INTERIOR WALL 3 NEW WALL PARTITION, TYPE C. SEE 2/A7.0. REUSE EXISTING REGISTERS AND RETROFIT WITH FLEXIBLE DUCTS TO 5. NEW RUBBER BASE ON ALL WALLS. SEE FINISH SCHEDULE FOR SPEC. NEW CEILING GRILLS. S. SEE SHEET A6.0 FOR CEILING DETAILS. WALL TO BE REMOVED 10 4 REMOVE EXISTING FIRE EXTINGUISHER, PAINT AND PATCH WALL TO SWITCH LIGHTS AS SHOWN. 7. SEE SHEET A7.0 FOR WALL PARTITION TYPES. MATCH EXISTING. 8. NEW LIGHTS TO BE INTEGRATED WITH BUILDING GE LIGHTING CONTROLLER AND HAVE MOTION 2'X4' LIGHT COOPER LIGHTING 130513-24EN-2X4-LED WITH DIMMING CONTROLS. 5 NEW 3'X4' CEILING ACCESS PANEL, COORDINATE LOCATION WITH DATA PORT TELEPHONE EQUIPMENT. PAINT TO MATCH CEILING. 9. SEE 3/A1.5 FOR FINISH SCHEDULE. 6 NEW GYPSUM BOARD SOFFIT. SEE 6/A6.0. ALIGN FACE WITH NEW QUAD OUTLET WALL. PAINT P-6. (7) NEW LED LIGHT, SEE LEGEND. DUPLEX OUTLET CEILING ACCESS PANEL

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San Francisco, CA

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Clients:
UC Hastings College of Law
200 McAllister Street
San Francisco, CA

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Seal:		

Scale: 1/8" = 1'-0"

Drawing Description:

## BASEMENT PLAN AND RCP IN 198 McALLISTER

Date:

Drawn By: -- Checked By: --

Sheet Number:

# NOTE ON EGRESS/ACCESSIBILITY EXISTING SPACE TO MAINTAIN EXISTING ACCESSIBLE PATH OF TRAVEL, ACCESSIBLE PARKING SPOTS, AND BATHROOM FACILITIES. NO CHANGE IN OVERALL BUILDING USE. CHANGE IN USE OF B27 FROM OFFICE (B) TO ACCESSORY STORAGE (S-1). OCCUPANT LOADS REQ. EXIT WIDTH PROV. EXIT

LOAD EXITS # EXITS

35" & 71"

10 1


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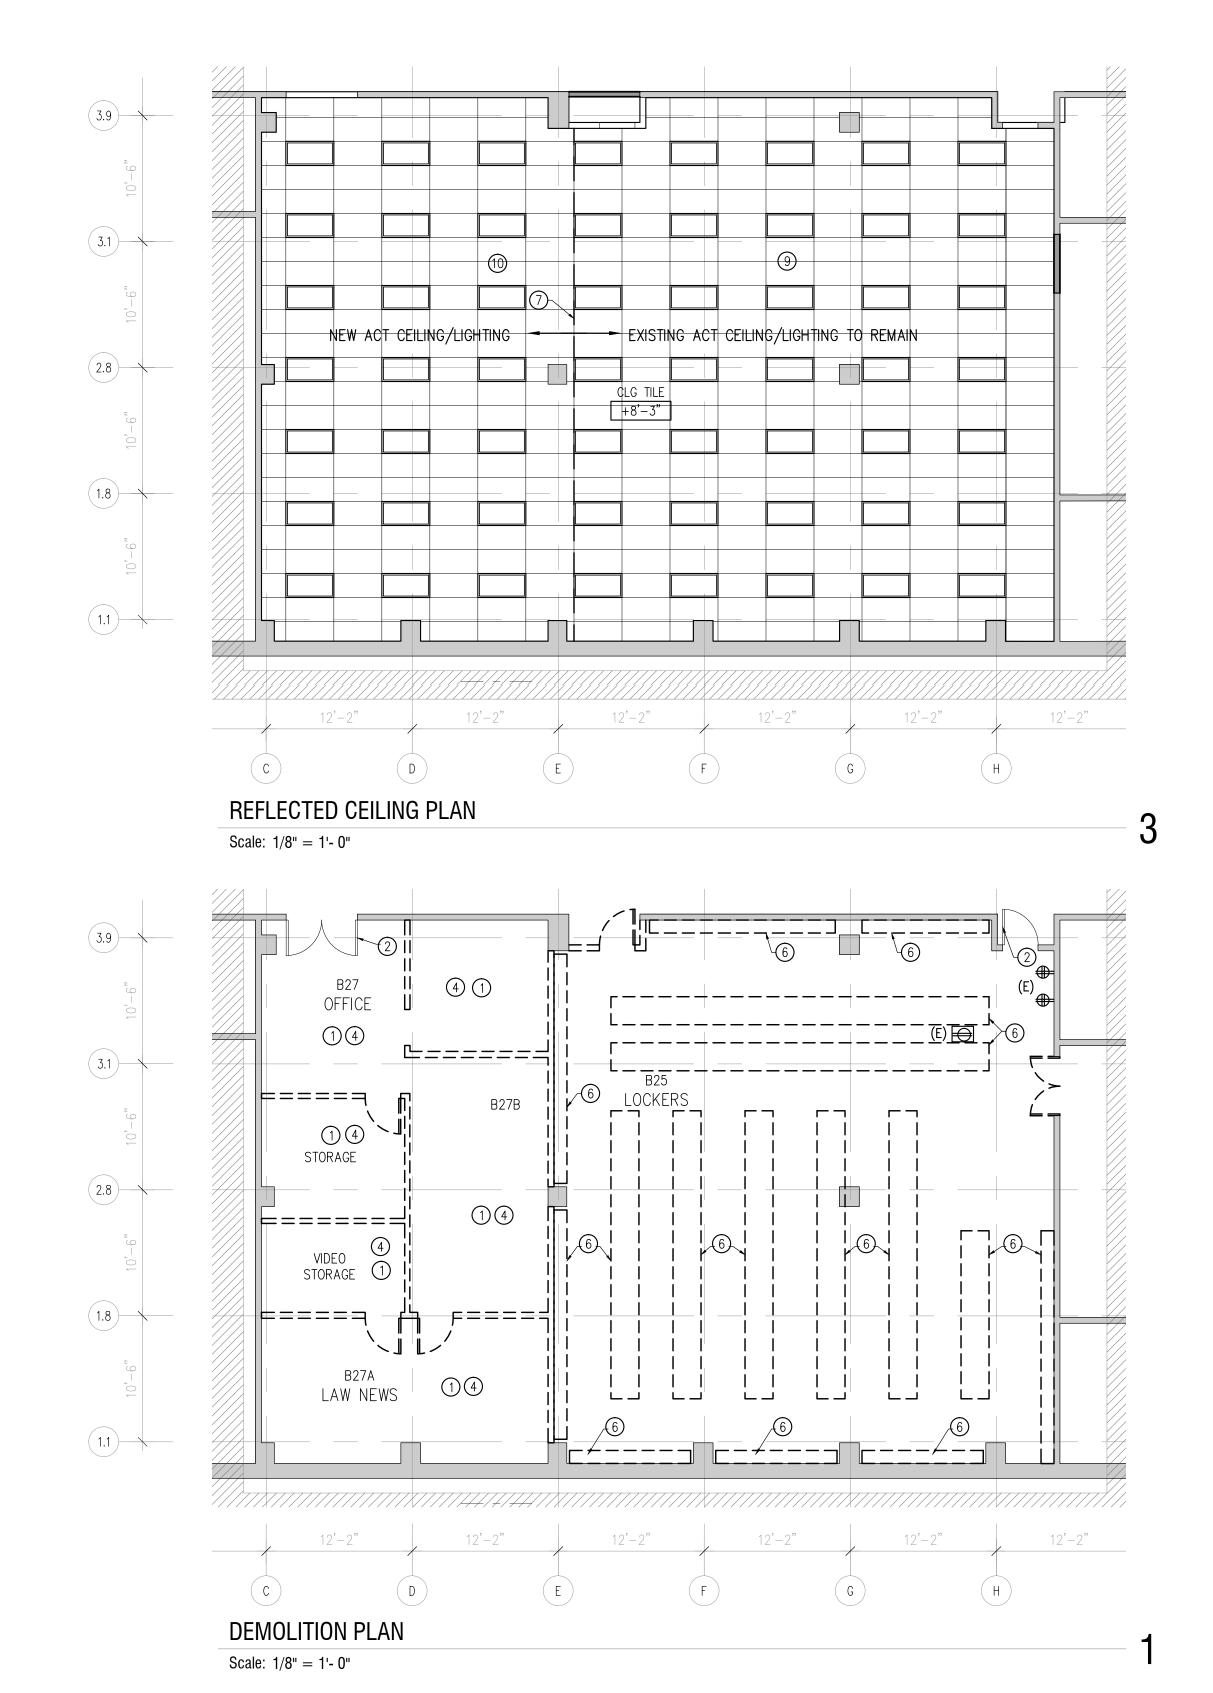
2,935 1:300

USE

HIGH DENSITY STORAGE B25

WALL, SEE 2B/A7.0.



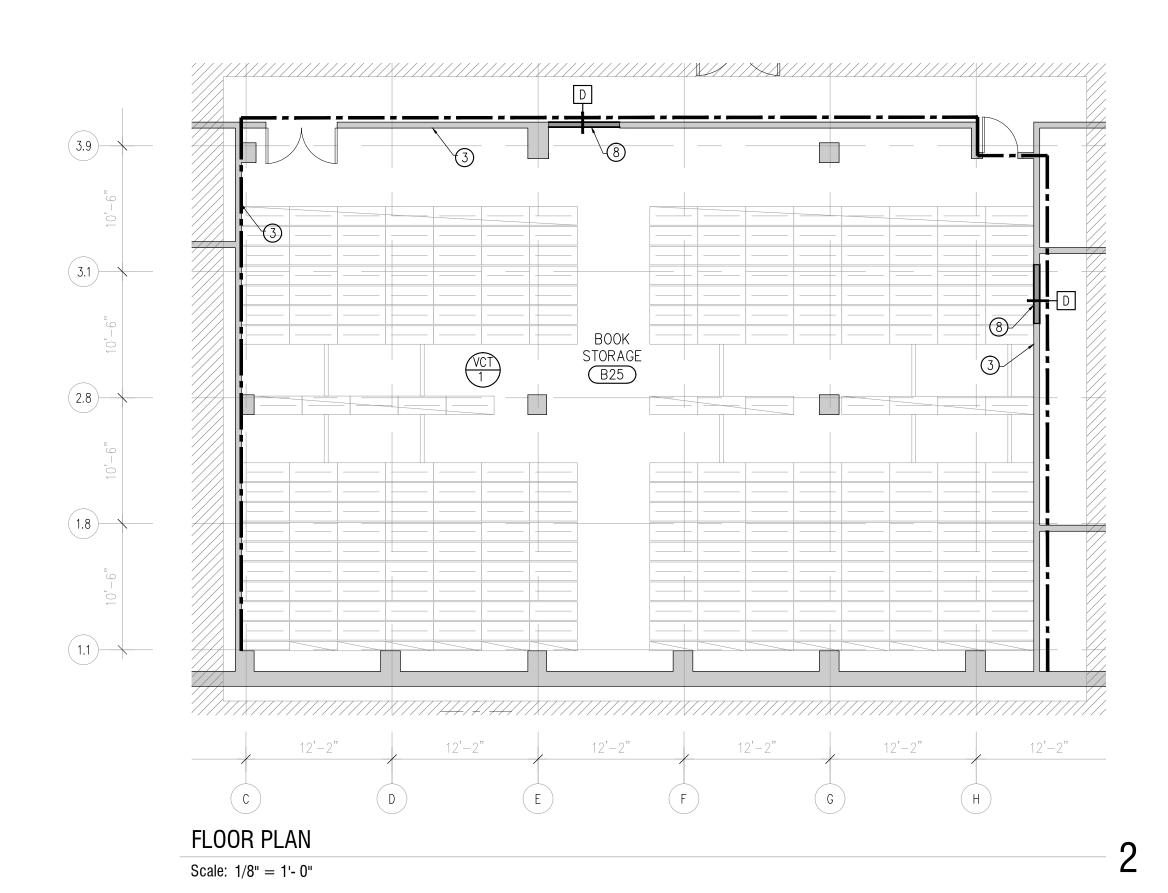

### **GENERAL NOTES** LEGEND PLAN KEYNOTES 1) REMOVE EXISTING CARPET. 1. ALLOW FOR PATCHING OF EXISTING WALLS AND COLUMNS TO MAKE SMOOTH. 9 EXISTING HVAC AND REGISTERS TO REMAIN. 2. PAINT WALLS P-1 UNLESS OTHERWISE NOTED. SEE FINISH SCHEDULE. EXISTING INTERIOR & EXTERIOR WALL RECONFIGURE EXISTING HVAC AND REGISTERS IN NEW CEILING. DISTRIBUTE UNIFORMLY. 3. SAVE REGISTERS, FIRE ALARM DEVICES FOR REUSE. RETURN UNUSED MATERIALS TO OWNER. 2 EXISTING DOOR TO REMAIN. 24" X 48" RECTANGULAR TILES (MATCH EXISTING) 4. NEW RUBBER BASE ON ALL WALLS. SEE FINISH SCHEDULE FOR SPEC. NEW FULL HEIGHT INTERIOR WALL 3 VERIFY WALL/DOORS ARE 1 HR PARTITIONS. CONTRACTOR 5. SEE SHEET 3/A1.5 FOR FINISH SCHEDULE. RESPONSIBLE FOR PATCHING ANY EXISTING PENETRATIONS TO 6. SEE SHEET A6.0 FOR CEILING DETAILS. -----WALL TO BE REMOVED MAKE 1 HR RATING. 7. SEE SHEET 2/A7.0 FOR WALL PARTITION TYPES. -----8. SAVE LIGHTS FOR REUSE 4 DEMO CEILING GRID. SAVE LIGHTS FOR REUSE IN NEW CEILING GRID. QUAD OUTLET 9. VCT FLOORING TO BE INSTALLED ON TOP OF HIGH DENSITY SHELVING FLOOR. COORDINATE 2'X4' BUILDING STANDARD DIRECT/INDIRECT LIGHT WITH SHELVING INSTALLER. DUPLEX OUTLET 10. NEW VCT FLOOR TO MATCH EXISTING VCT FLOOR. 11. REPLACE CEILING TILE AS NEEDED. DUPLEX FLOOR BOX OUTLET 6 DEMO CONCRETE LOCKER PADS. 12. HIGH DENSITY STORAGE SHOWN FOR REFERENCE. BY OTHERS. 13. RECONFIGURE FIRE ALARM TO MEET REQUIRED CODES. 1 HR RATED WALL 7 ALIGN NEW CEILING TILE WITH EXISTING. 8 DEMO EXISTING DOOR AND FRAME. INFILL OPENING WITH 1 HOUR

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200 McAllister Street San Francisco, CA

Project Number: 491-142



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Rev.	Issue	Date
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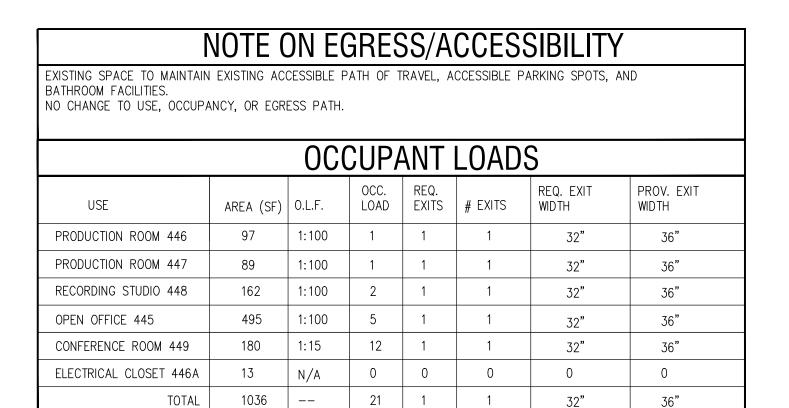
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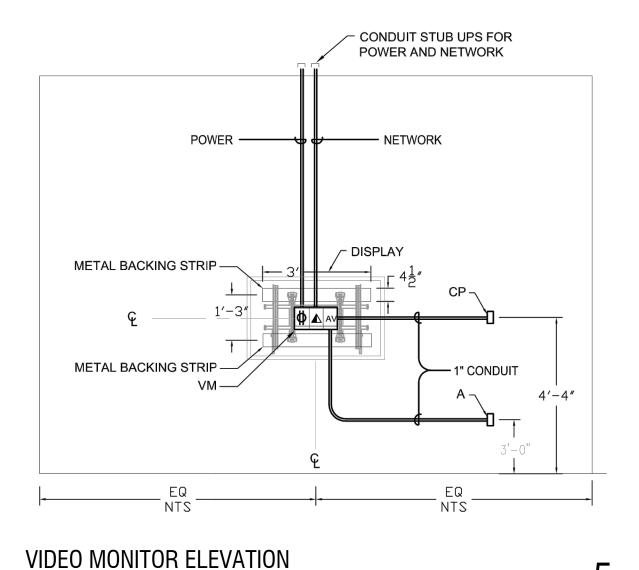
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HIGH DENSITY STORAGE **PLANS IN 198 MCALLISTER** 


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Scale: NTS



Scale: 1/8"=1'-0"

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mkthink.com

Project:

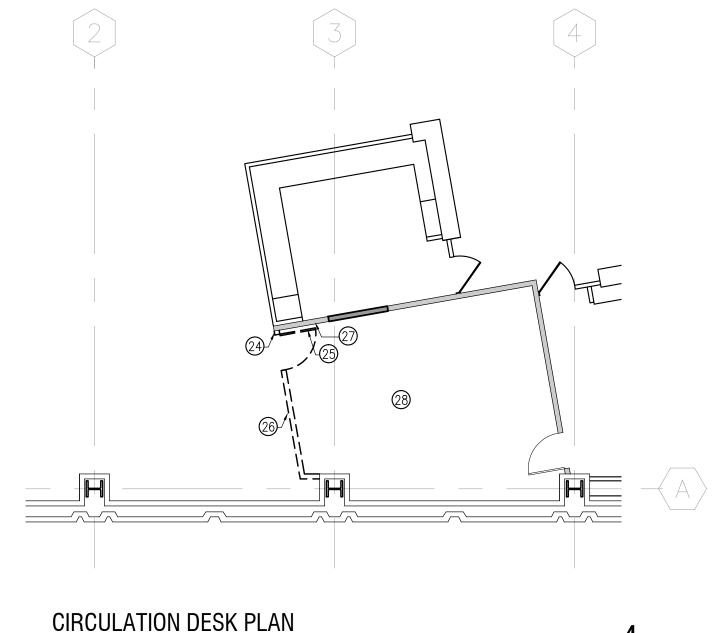San Francisco, CA 94111

MKTHINK

Roundhouse One, 1500 Sansome Street

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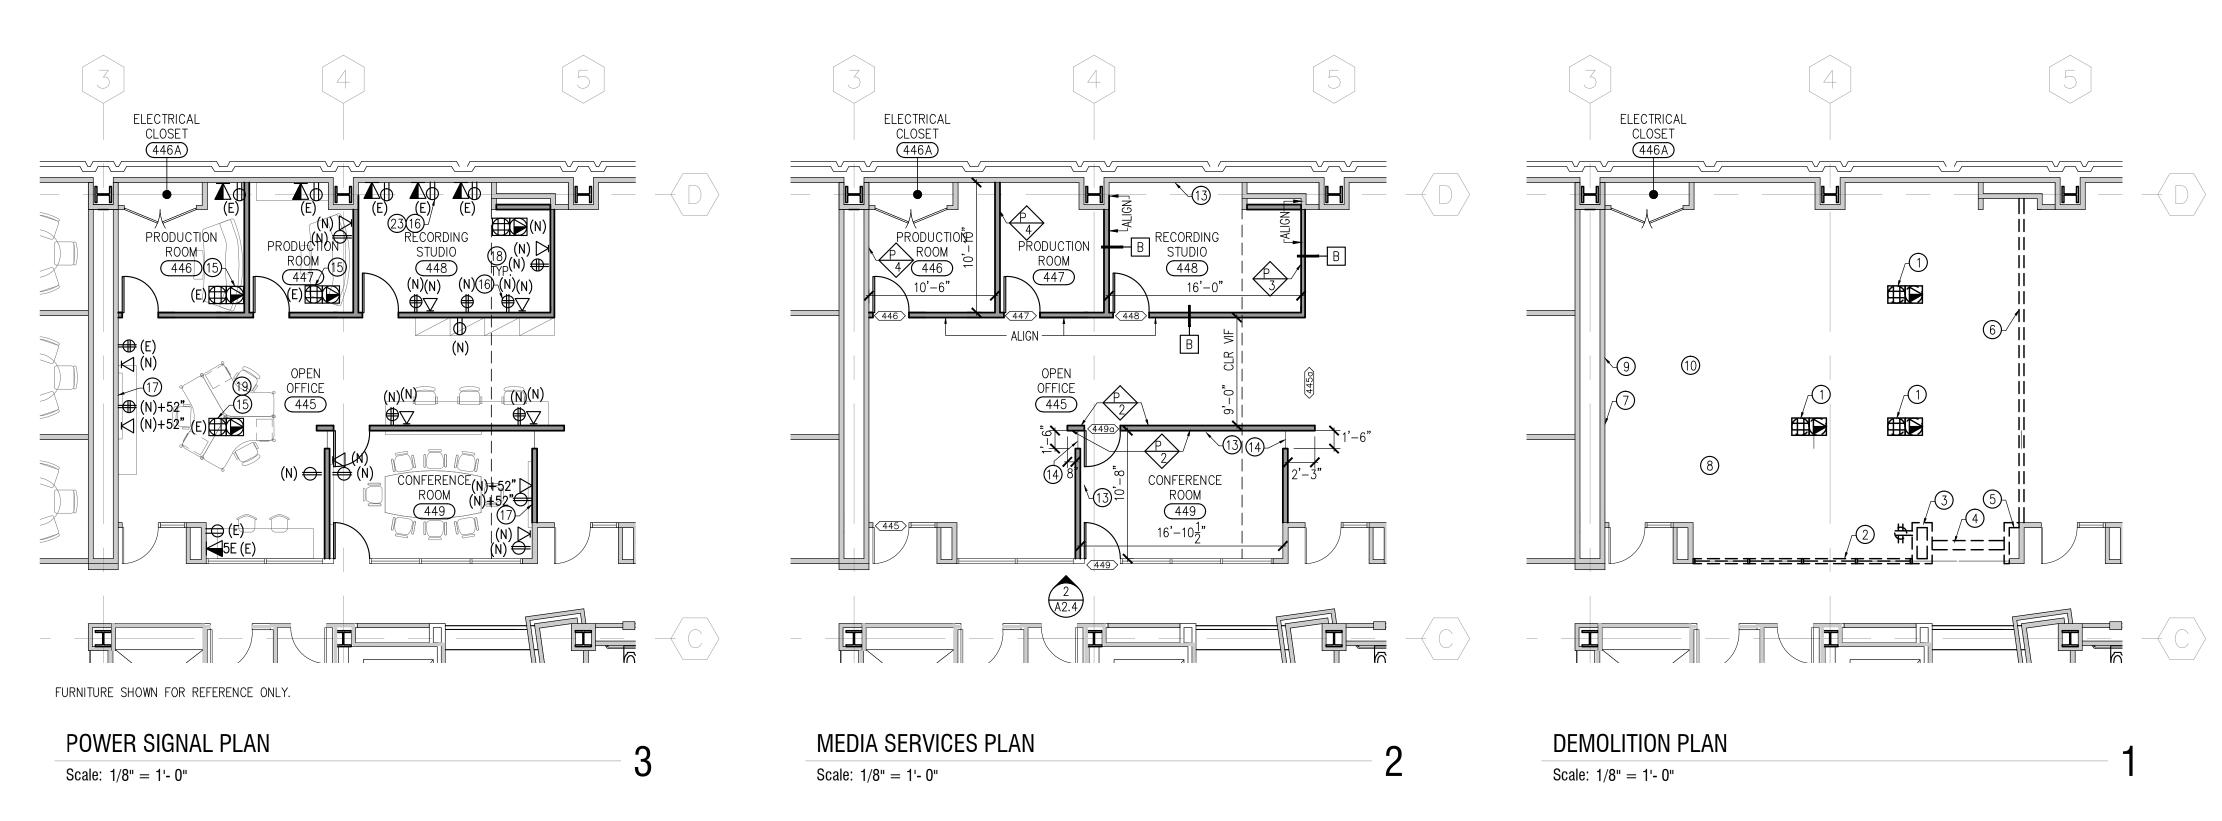
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Media Services Relocation

200 McAllister Street

San Francisco, CA

Project Number:



Rev.	Issue	Date
	BID SET	1.9.14
Seal:		

**GENERAL NOTES** PLAN KEYNOTES LEGEND 1) REMOVE AND PATCH FLOOR AT EXISTING FLOOR BOX. 1. PATCH EXISTING WALLS WHERE CONSTRUCTION REMOVED, AS NEEDED. 11) REMOVE AND SAVE EXISTING LIGHTS, CEILING TILES, REGISTERS, FIRE ALARM DEVICES FOR EXISTING INTERIOR & EXTERIOR WALL REUSE. RETURN UNUSED MATERIALS TO OWNER. (2) REMOVE EXISTING STOREFRONT SYSTEM. LOCATE POWER AND DATA AT 18" AFF. UNLESS OTHERWISE INDICATED. NEW FULL HEIGHT INTERIOR WALL PROVIDE 2-GANG BACKBOX WITH 1" CONDUIT ABOVE CEILING. 3 REMOVE WALL CONSTRUCTION AND RELOCATE ANY INSIDE INFRASTRUCTURE. NEW 4'X5' POLYVISION E3 ENVIRONMENTAL CERAMICSTEEL SURFACE 4. PROVIDE BACKING AS REQUIRED. CONFIRM WITH ARCHITECT. 5. SEE SHEET A1.5 FOR FINISH SCHEDULE CUT BACK WALL TO 8' AFF, KEEP SOFFIT ABOVE SIMILAR TO 3/A7.0. (4) REMOVE EXISTING SLANTED GLASS WINDOW. FRAMELESS GLASS WINDOW, SEE DETAIL 1/A7.0. WALL TO BE REMOVED 6. NEW WALLS TO BE TYPE A U.O.N. PROTECT AND PATCH FLOOR AS NEEDED. 7. PAINT WALLS TO MATCH EXISTING UNLESS OTHERWISE NOTED. SEE FINISH SCHEDULE. (5) REMOVE WALL CONSTRUCTION AND RELOCATE ANY INSIDE INFRASTRUCTURE. (15) REMOVE DOOR AND FRAME. DATA PORT LEAVE EXISTING FLOOR BOX FOR FUTURE USE. 8. SEE SHEET A6.0 FOR CEILING DETAILS. FINISH EXPOSED WALL TO MATCH EXISTING ADJACENT WALL. 9. SEE SHEET A7.0 FOR WALL PARTITION TYPES. (6) BRING FOLDING WALL UP TO CEILING, REMOVE MOTORIZED CONTROLS TO RELOCATE EXISTING FIRE EXTINGUISHER. QUAD OUTLET 10. PROTECT CARPET DURING CONSTRUCTION AND REPLACE AS NEEDED. SECURE WALL IN OPEN POSITION. 11. PARTITIONS DIMENSIONED TO FINISH FACE U.O.N. 7) REMOVE EXISTING PROJECTION SCREEN AND PROJECTOR. RETURN TO OWNER. 17 RELOCATED FIRE EXTINGUISHER. INPUT BACK BOX. PROVIDE 1" CONDUIT AND BACKING PER ELEVATION DUPLEX OUTLET 12. NEW LIGHTS TO BE INTEGRATED WITH BUILDING GE LIGHTING CONTROLLER AND MOTION acoustical sealant around all new wall penetrations, including (28) NEW 2'X4' LIGHT COOPER LIGHTING 130513-24EN-2X4-LED WITH DIMMING CONTROLS. (8) REMOVE EXISTING CEILING TILES. SAVE AND REUSE EXISTING LIGHTS. NO WORK ON EXISTING CEILING. 13. RECONFIGURE FIRE ALARM TO MEET REQUIRED CODES. BACK BOXES AND RECEPTACLES, TYP. IN RECORDING STUDIO. 19 PROVIDE 4" CONDUIT PATH FROM FLOOR BOX TO BACK BOX BEHIND TV. REMOVE AND SAVE EXISTING CONTROL PANEL. PATCH WALL TO MATCH (10) EXISTING CARPET TO REMAIN. PROTECT AND REPLACE AS NEEDED.

Scale: AS NOTED

**Drawing Description:** 

4th FLOOR PLANS/FINISH **SCHEDULE IN 200 McALLISTER** 


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Sheet Number:

### NOTE ON EGRESS/ACCESSIBILITY EXISTING SPACE TO MAINTAIN EXISTING ACCESSIBLE PATH OF TRAVEL, ACCESSIBLE PARKING SPOTS, AND BATHROOM FACILITIES. NO CHANGE IN OVERALL BUILDING USE. NO CHANGE IN USE TO ROOM 425. CHANGE IN USE FROM STORAGE TO OPEN OFFICE IN ROOMS 424 & 427. OCCUPANT LOADS OCC. REQ. LOAD EXITS # EXITS REQ. EXIT WIDTH PROV. EXIT USE AREA (SF) O.L.F. WIDTH READING ROOM 424 1:50 36" READING ROOM 425 1:50 2 | 1 32"

2


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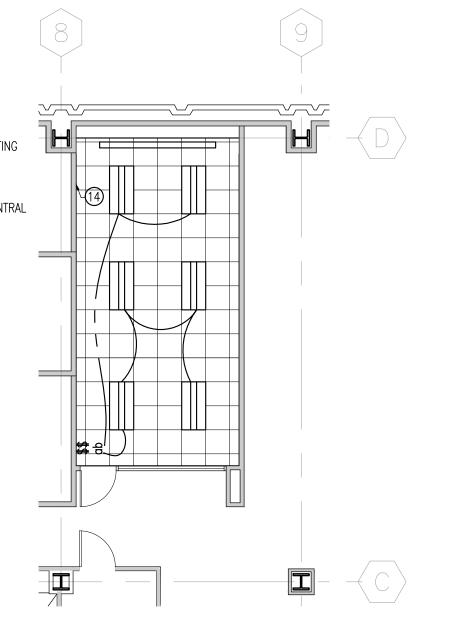
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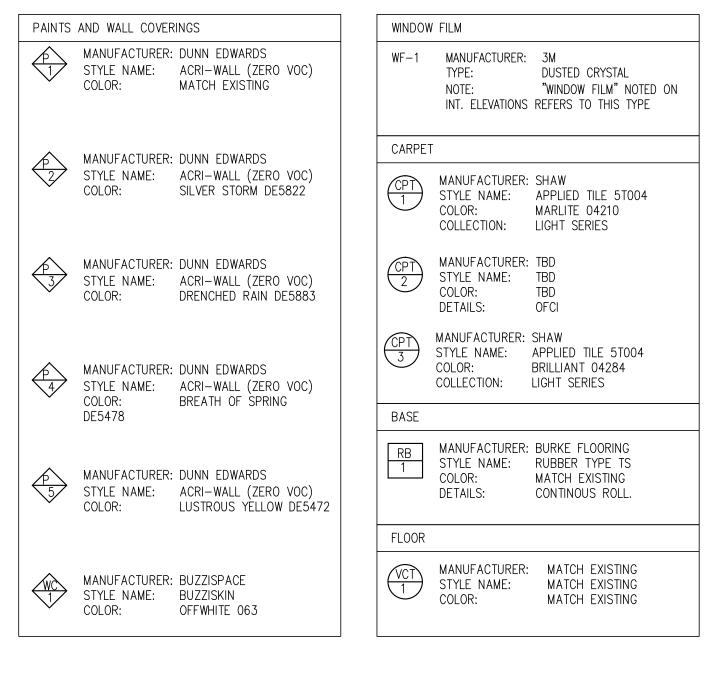
OPEN OFFICE 427\*

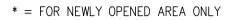


TRAINING ROOM


Scale: 1/8" = 1' - 0"



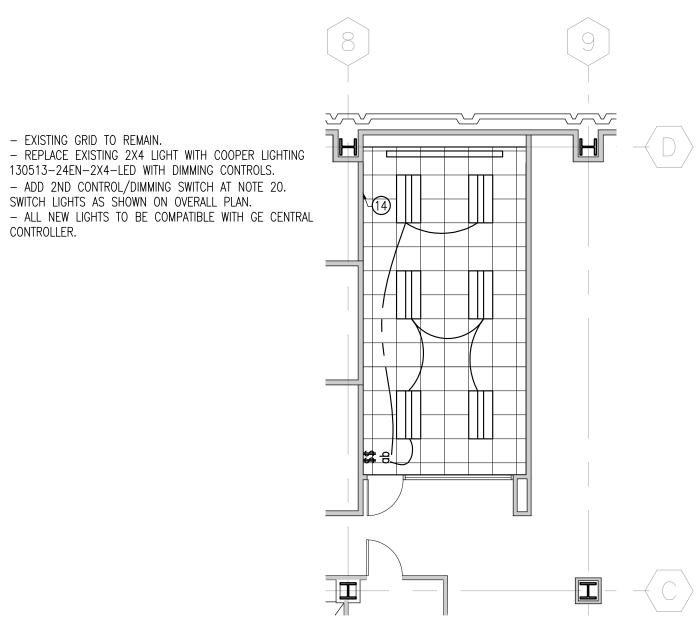



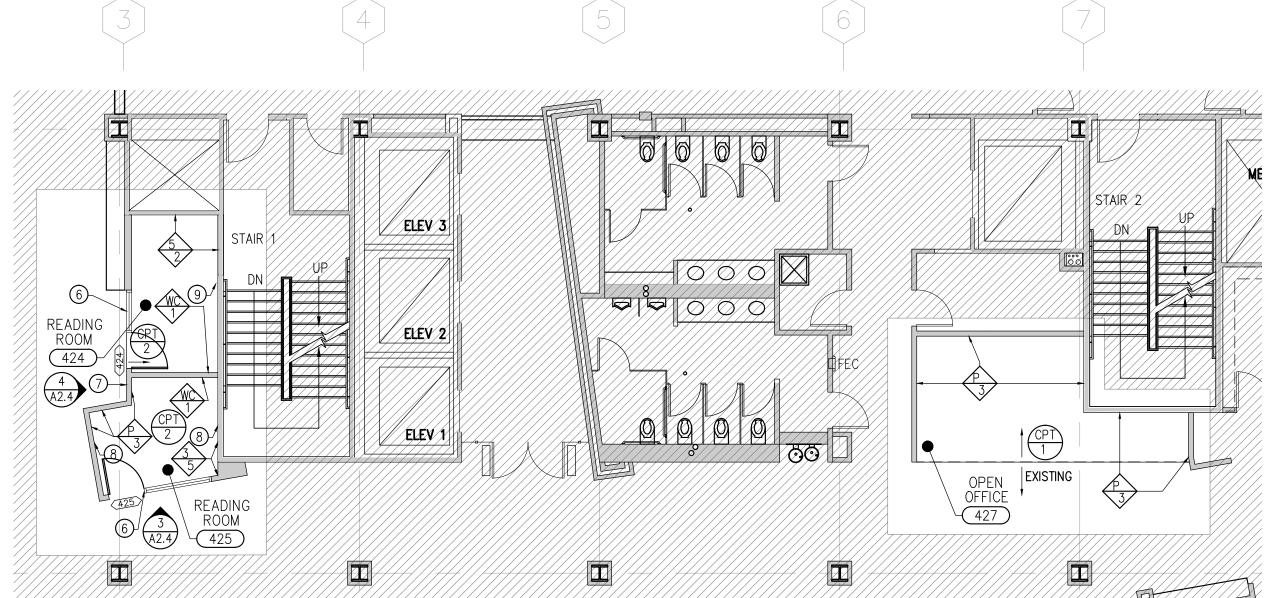

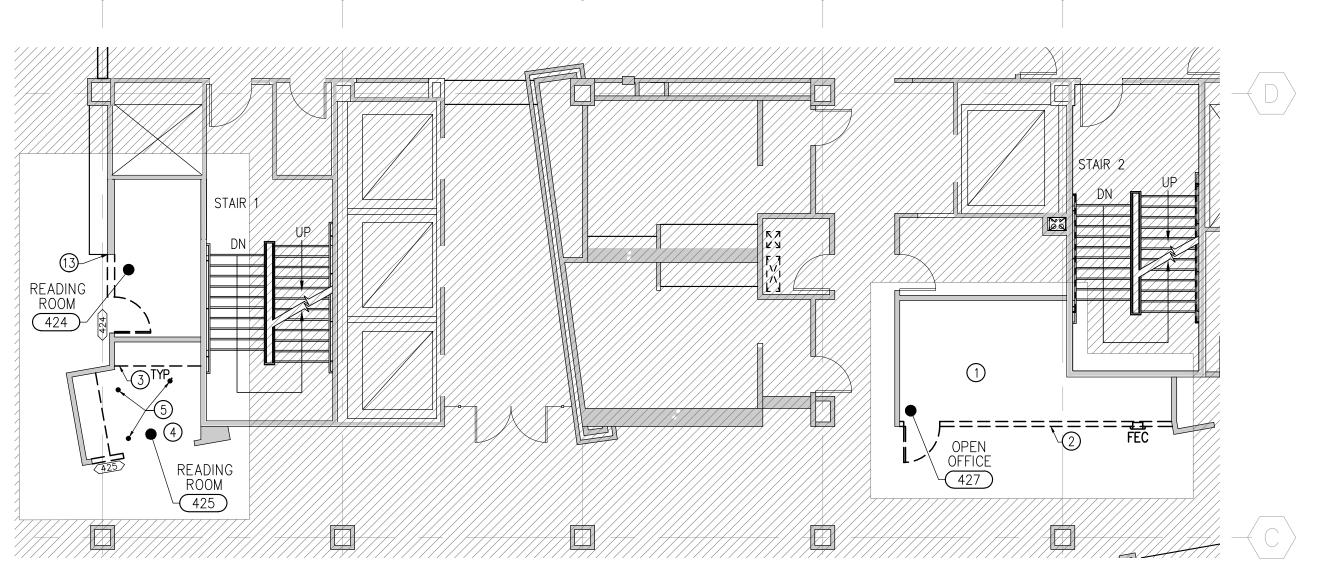

PLAN **DEMOLITION PLAN** Scale: 1/8" = 1'- 0" Scale: 1/8" = 1'- 0"

PLAN KEYNOTES		GENERAL NOTES		LEGEND
REMOVE AND SAVE EXISTING LIGHTS. RETURN TO OWNER. REPLACE CEILING TILES AS NEEDED, MATCH EXISTING.  CUT BACK WALL TO FORM SOFFIT EDGE AT 8'-6" AFF, SEE 3/A7.0. REMOVE EXISTING FIRE EXTINGUISHER CABINET. RELOCATE PHONE. REMOVE EXISTING SOLID SURFACE COUNTER.  EXISTING SOFFIT TO REMAIN. RELOCATE DOWN LIGHTS AND PATCH CEILING.  REMOVE AND RELOCATE EXISTING LIGHT FROM CEILING.  NEW ALUMINUM FRAME STOREFRONT SYSTEM WITH GLASS SIDELIGHT, MATCH EXISTING.  RELOCATED EXISTING PHONE.	① ② ① CUT BACK EXISTING WALL TO 4" FROM EXISTING BOOKCASE ① 2ND CONTROL/DIMMING SWITCH. SWITCH LIGHTS AS SHOWN ON OVERALL PLAN.	1. PATCH EXISTING WALLS WHERE CONSTRUCTION REMOVED, AS NEEDED. 2. PROVIDE BACKING AS REQUIRED. 3. NEW WALLS TO BE TYPE A U.O.N. 4. PAINT WALLS TO MATCH EXISTING UNLESS OTHERWISE NOTED. SEE FINISH SCHEDULE. 5. SEE SHEET A6.0 FOR CEILING DETAILS. 5. SEE SHEET A1.5 FOR FINISH SCHEDULE 6. SEE SHEET A7.0 FOR WALL PARTITION TYPES. 7. PROTECT CARPET DURING CONSTRUCTION AND REPLACE AS NEEDED. 8. FURNITURE SHOWN FOR REFERENCE ONLY. 9. RECONFIGURE FIRE ALARM TO MEET REQUIRED CODES.	\( \times \\ \t	EXISTING INTERIOR & EXTERIOR WALL  NEW FULL HEIGHT INTERIOR WALL  WALL TO BE REMOVED
NEW 4'X5' POLYVISION E3 ENVIRONMENTAL CERAMICSTEEL SURFACE      NEW 4'X6' POLYVISION E3 ENVIRONMENTAL CERAMICSTEEL SURFACE				

# MKTHINK

### Architects:

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Project:

Media Services Relocation 200 McAllister Street San Francisco, CA

Project Number: 491-142



UC Hastings College of Law 200 McAllister Street San Francisco, CA

> Rev. Issue Date 1.9.14 BID SET Seal:

Scale: AS NOTED

Drawing Description:

4th FLOOR STUDY ROOMS **IN 200 McALLISTER** 

Checked By: --Drawn By: --

Sheet Number:


# DOOR SCHEDULE


DOOR			FRAME TYPE		FIRE RATING	HARDWARE				
DOOR NUMBER	TYPE (1)	SIZE (2)	MATERIAL (4)	FINISH (6)	MATERIAL (8)	FINISH (10)	(11)	SET NO.	ELECTRICAL	NOTES
424	С	MATCH EXISTING	GLASS/ALUM.	CLEAR	ALUM.	FF	NR	4		MATCH EXISTING DOORS
425	С	MATCH EXISTING	GLASS/ALUM.	CLEAR	ALUM.	FF	NR	4		MATCH EXISTING DOORS
445	А	3'-0" x 7'-0"	EXISTING	(E)	(E)	(E)	NR	(E)		EXISTING
446	А	3'-0" x 7'-0"	WD	CLEAR	AL	FF	NR	1		MATCH EXISTING DOORS
447	A	3'-0" x 7'-0"	WD	CLEAR	AL	FF	NR	1		MATCH EXISTING DOORS
448	A	3'-0" x 7'-0"	НМ	CLEAR	НМ	PTD.	NR	3		STC-48 DOOR AND FRAME
449a	A	3'-0" x 7'-0"	WD	CLEAR	AL	FF	NR	1		MATCH EXISTING DOORS
449	А	3'-0" x 7'-0"	WD	CLEAR	AL	FF	NR	1		MATCH EXISTING DOORS

- 1. TYPE: SEE ELEVATIONS FOR DOOR TYPES. 2. SIZE: ALL DOORS TO BE 1-3/4" THICK WITH 3/8 UNDERCUT U.O.N. 4. MATERIAL: WD = SOLID CORE WOOD DOOR
- 8. FRAME MATERIAL: AL = ALUMINUM TO MATCH EXISTING10. FRAME FINISH: FF = FACTORY FINISH CLEAR TO MATCH EXISTING
- 11. NR = NONE REQUIRED.


# HARDWARE SETS

- 1. WOOD DOOR HARDWARE LATCHSET HINGES
- DOOR STOP CLASSROOM LOCKSET
- 2. NOT USED.
- 3. ACOUSTIC DOOR HARDWARE ZERO INTERNATIONAL SOUND TRAP 49 STC SEALING SYSTEM 119W DOOR SEAL 870 HEAD AND JAM SEAL ZBB961 HINGES (2 PAIRS) SADDLE 564, 565, OR 566 THRESHOLD CLASSROOM LOCKSET
- 4. ALUMINUM DOOR LATCH SET HINGES DOORSTOP PASSAGE LOCKSET

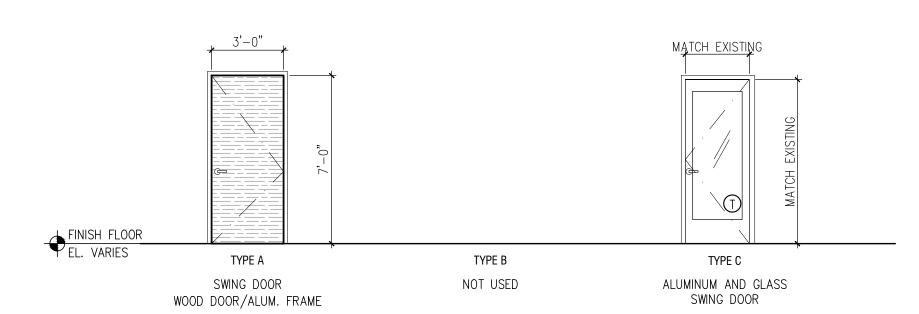

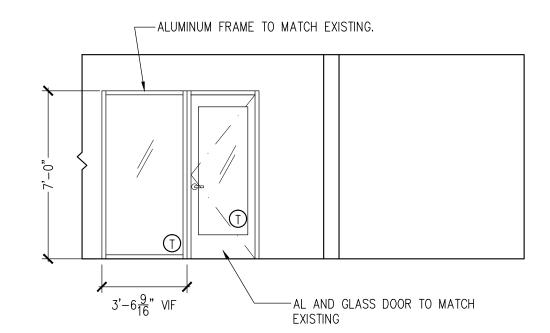

INTERIOR STOREFRONT ELEVATION RM 424 Scale: 1/4" = 1' - 0"

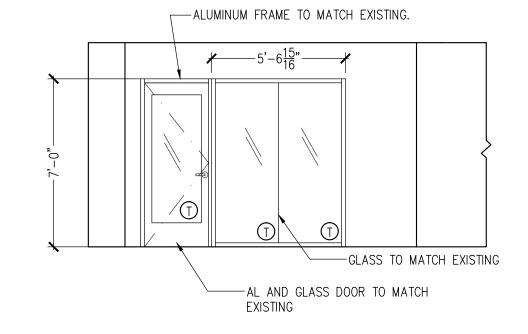

INTERIOR STOREFRONT ELEVATION RM 425

Scale: 1/4" = 1' - 0"

200 McAllister Street San Francisco, CA Project Number: 491-142

Clients: UC Hastings College of Law 200 McAllister Street San Francisco, CA

Rev. Issue

BID SET

Date 1.9.14

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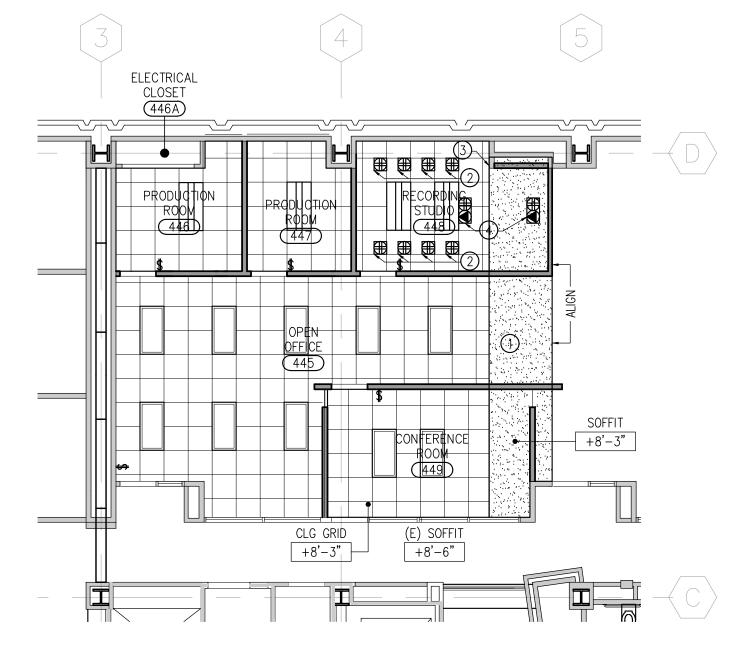
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Project:

**/** EQ **/** EQ **/** EQ **/** EQ **/** EXISTING WOOD DOOR— -- WOOD DOOR TO MATCH EXISTING  $^{\prime}$  ALUMINUM FRAME TO MATCH EXISTING. -BREAK SHAPE TO MATCH EXISTING EXISTING WINDOW ----SEE FINISH SCHEDULE FOR FILM

INTERIOR STOREFRONT ELEVATION RM 449

Scale: 1/4" = 1' - 0"



REFLECTED CEILING PLAN

Scale: 1/8" = 1' - 0"

Scale: AS NOTED

Seal:

Drawing Description: 4th FLOOR CEILING

AND DOOR SCHEDULE

Drawn By: --Checked By: --

Sheet Number:

	REFLECTED	<b>CEILING</b>	PLAN	<b>KEYNOTES</b>
$\overline{}$				

- (1) GYPSUM BOARD SOFFIT BELOW EXISTING FOLDED WALL PARTITION, SEE 5/A6.0.
- 2) PRICE AS ALTERNATE: 4 QUADS ON 1 DEDICATED CIRCUIT.
- 3 ALIGN EDGE OF NEW SOFFIT WITH EXISTING WALL.
- 4) PRICE AS ALTERNATE.

### 1. REUSE EXISTING LIGHTS AND CEILING TILES WHERE POSSIBLE. RETURN UNUSED ITEMS TO 2. LOCATE POWER AND DATA AT 18" AFF. UNLESS OTHERWISE INDICATED. PROVIDE BACKING AS REQUIRED. 4. NEW WALLS TO BE TYPE A U.O.N. 5. PAINT WALLS FLAT WHITE TO MATCH EXISTING UNLESS OTHERWISE NOTED. SEE FINISH SCHEDULE. 6. SEE SHEET A7.0 FOR WALL PARTITION TYPES. 7. ALL CEILING HEIGHTS TO BE 8'-6" U.O.N.

9. NEW LIGHTS TO BE INTEGRATED WITH BUILDING GE LIGHTING CONTROLLER AND HAVE MOTION

8. RECONFIGURE FIRE ALARM TO MEET REQUIRED CODES.

SENSORS.

**GENERAL NOTES** 

LEGEND EXISTING INTERIOR & EXTERIOR WALL NEW FULL HEIGHT INTERIOR WALL \_\_\_\_\_ WALL TO BE REMOVED DATA PORT SURFACE-MOUNTED QUAD OUTLET CEILING SURFACE-MOUNTED POWER

AND DATA

NEW 2'X4' LIGHT COOPER LIGHTING 130513-24EN-2X4-LED WITH DIMMING CONTROLS.

ARMSTRONG CEILING SYSTEM

24"x 24" SQUARE TEGULAR TILES

REUSED EXISTING BUILDING STANDARD LIGHT TEMPERED GLASS

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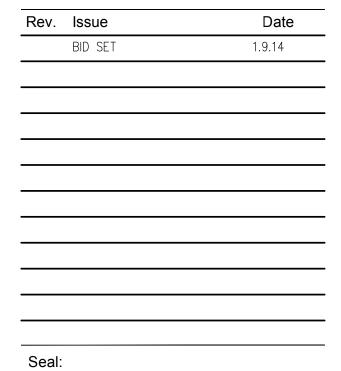
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Project: Media Services Relocation 200 McAllister Street San Francisco, CA

Project Number: 491-142



UC Hastings College of Law 200 McAllister Street San Francisco, CA



# Scale: **AS NOTED**

Drawing Description:

4th FLOOR STUDY ROOMS **IN 200 McALLISTER** 


24"x 24" SQUARE TEGULAR TILES, MATCH BUILDING STANDARD.

2'X4' LIGHT COOPER LIGHTING 130513-24EN-2X4-LED WITH DIMMING CONTROLS

Checked By: --Drawn By: --

Sheet Number:

**A2.5** 

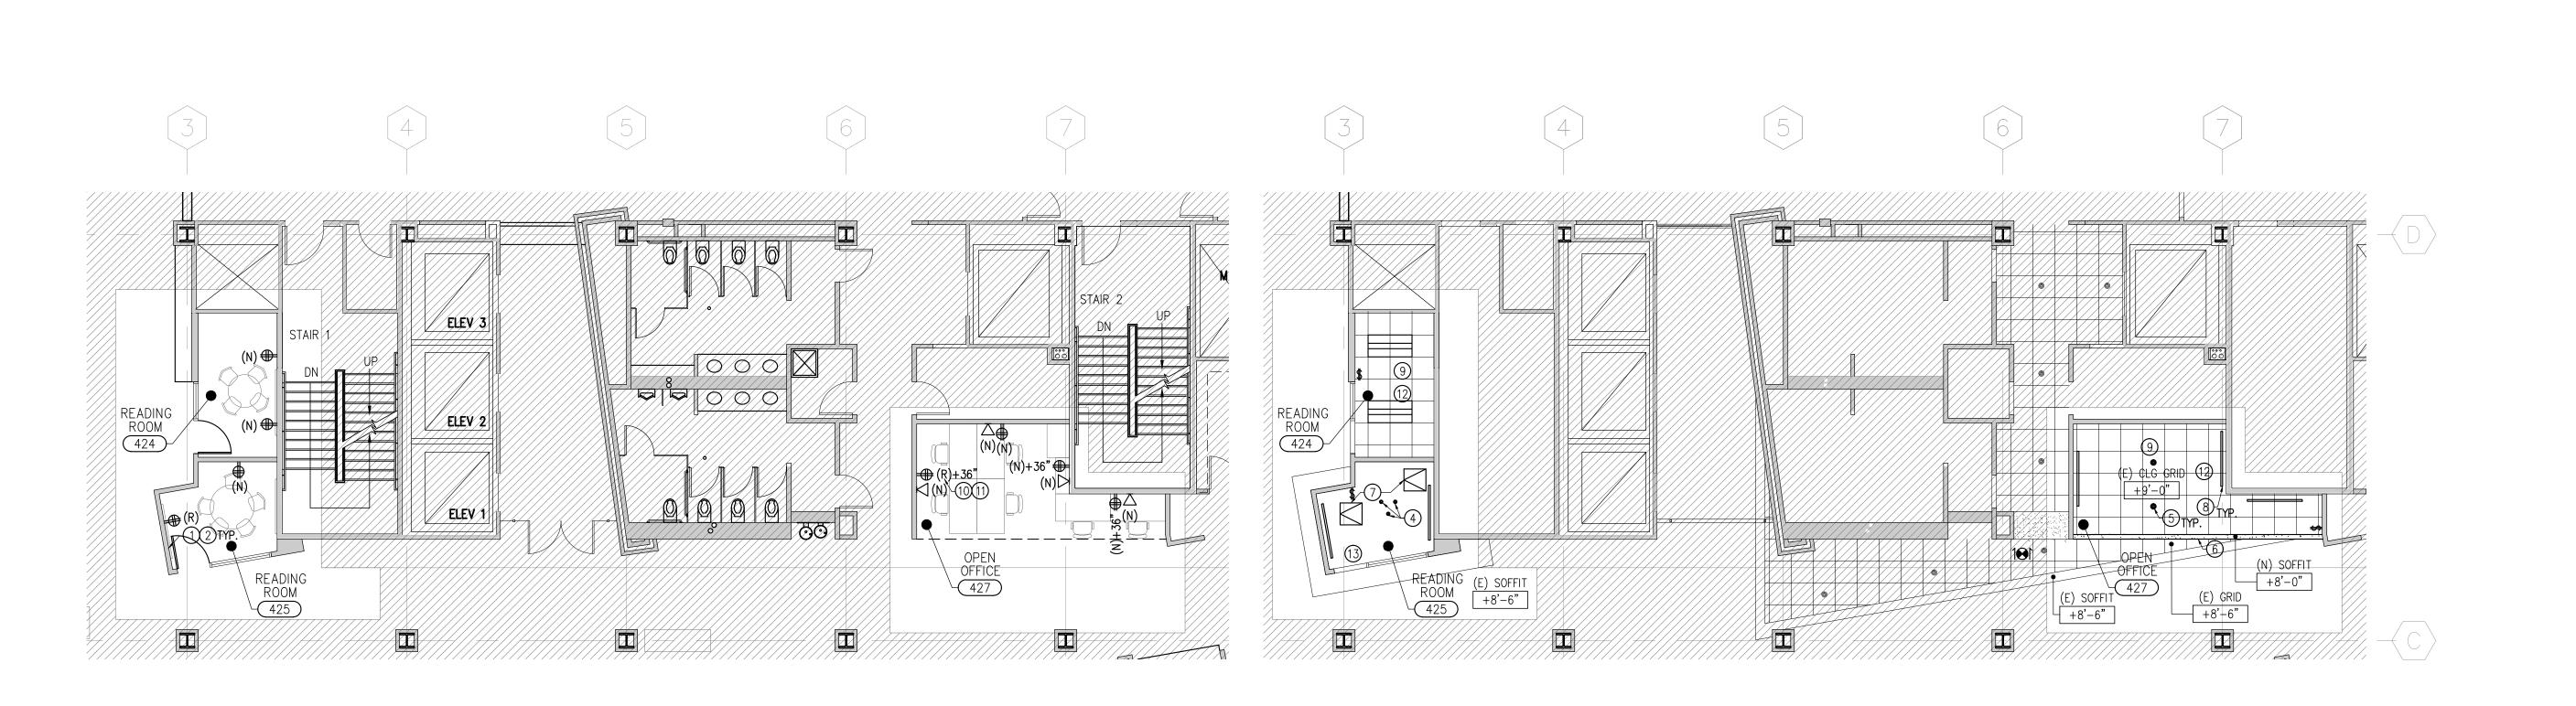

REFLECTED CEILING PLAN

**GENERAL NOTES** 

PATCH EXISTING WALLS WHERE CONSTRUCTION REMOVED, AS NEEDED.
REMOVE AND SAVE EXISTING LIGHTS, CEILING TILES, REGISTERS, FIRE ALARM DEVICES FOR

6. PAINT WALLS TO MATCH EXISTING UNLESS OTHERWISE NOTED. SEE FINISH SCHEDULE.

11. NEW LIGHTS TO BE INTEGRATED WITH BUILDING GE LIGHTING CONTROLLER AND MOTION

LEGEND

WALL TO BE REMOVED

DATA PORT

QUAD OUTLET

DUPLEX OUTLET

 $\Rightarrow$ 

EXISTING INTERIOR & EXTERIOR WALL

NEW FULL HEIGHT INTERIOR WALL

Scale: 1/8" = 1' - 0"

REUSE. RETURN UNUSED MATERIALS TO OWNER.

7. SEE SHEET A6.0 AND A7.0 FOR CEILING DETAILS.

10. PARTITIONS DIMENSIONED TO FINISH FACE U.O.N.

12. RECONFIGURE FIRE ALARM TO MEET REQUIRED CODES.

8. SEE SHEET A7.0 FOR WALL PARTITION TYPES.

4. PROVIDE BACKING AS REQUIRED.

5. NEW WALLS TO BE TYPE A U.O.N.

3. LOCATE POWER AND DATA AT 18" AFF. UNLESS OTHERWISE INDICATED.

9. PROTECT CARPET DURING CONSTRUCTION AND REPLACE AS NEEDED.

POWER SIGNAL PLAN

PLAN KEYNOTES

1 REMOVE EXISTING DATA PORTS AND PATCH WALLS, TYP.

(5) NEW DOWNLIGHT TO MATCH EXISTING IN ADJACENT ACT SOFFIT.

6 NEW GYPSUM BOARD SOFFIT, SEE 3/A7.0. PAINT P-3, SEE FINISH SCHEDULE 3/A1.5.

(9) EXISTING CEILING GRID TO REMAIN. REPLACE TILES WHERE NECESSARY.

8 NEW 62" ARTIMIDE 2 SQUARE SUSPENSION SYSTEM INDIRECT FLOURESCENT LIGHT. LOCATE 4" FROM ADJACENT WALL AND 8' AFF TO BOTTOM OF FIXTURE.

(2) RELOCATE EXISTING POWER TO 18" AFF.

7 EXISTING ACCESS PANEL TO REMAIN.

10) RELOCATE EXISTING POWER TO 40" AFF.

4) RELOCATED DOWNLIGHT.

(1) CONVERT DUPLEX TO QUAD.

EXISTING HVAC AND REGISTERS TO REMAIN.

NEW GRILLS. DISTRIBUTE UNIFORMLY.

REUSE EXISTING HVAC AND REGISTERS IN NEW CEILINGS WITH FLEX DUCTS TO


Scale: 1/8" = 1' - 0"

- 1. #12 GAGE (MIN.) HANGER WIRES MAY BE USED FOR UP TO AND INCLUDING 4'-0" X 4'-0" GRID SPACING ÄND SHALL BE ATTACHED TO MAIN RUNNERS.
- 2. PROVIDE #12 GAGE HANGER WIRES AT THE ENDS OF ALL MAIN AND CROSS RUNNERS WITHIN 8" OF THE SUPPORT OR WITHIN 1/4 OF THE LENGTH OF THE END TEE, WHICHEVER IS LEAST, FOR THE PERIMETER OF THE CEILING AREA. END CONNECTIONS FOR RUNNERS WHICH ARE DESIGNED AND DETAILED TO RESIST THE APPLIED VERTICAL AND HORIZONTAL FORCES MAY BE USED IN LIEU OF THE #
- 3. PROVIDE TRAPEZE OR OTHER SUPPLEMENTARY SUPPORT MEMBERS AT OBSTRUCTIONS TO TYPICAL HANGER SPACING. PROVIDE ADDITIONAL HANGERS, STRUTS OR BRACES AS REQUIRED AT ALL CEILING BREAKS, SOFFITS OR DISCONTINOUS AREAS. HANGER WIRES THAT ARE MORE THAN 1 IN 6 OUT OF PLUMB ARE TO HAVE COUNTER-SLOPING WIRES.
- 4. CEILING GRID MEMBERS MAY BE ATTACHED TO NOT MORE THAN 2 ADJACENT WALLS. CEILING GRID MEMBERS SHALL BE AT LEAST 3/4" CLEAR OF OTHER WALLS. IF WALLS RUN DIAGONALLY TO CEILING GRID SYSTEM RUNNERS, ONE END OF MAIN AND CROSS RUNNERS SHOULD BE FREE, AND A MINIMUM OF 3/4" CLEAR OF WALL.
- 5. AT THE PERIMETER OF THE CEILING AREA WHERE MAIN OR CROSS RUNNERS ARE NOT CONNECTED TO THE ADJACENT WALL, PROVIDE INTERCONNECTION BETWEEN THE RUNNERS AT THE FREE END TO PREVENT LATERAL SPREADING. A METAL STRUT OR A #16 GAGE WIRE WITH A POSITIVE MECHANICAL CONNECTION TO THE RUNNER MAY BE USED. WHERE THE PERPENDICULAR DISTANCE FROM THE WALL TO THE FIRST PARALLEL RUNNER IS 12" OR LESS, THIS INTERLOCK IS NOT REQUIRED.
- 6. PROVIDE BRACING ASSEMBLIES CONSISTING OF A COMPRESSION STRUT AND FOUR #12 GAGE SPLAYED BRACING WIRES ORIENTED 90 DEGREES FROM EACH OTHER AT THE FOLLOWING SPÄCING: 1.) FOR SCHOOL BUILDINGS, PLACE BRACING ASSEMBLIES AT A SPACING NOT MORE THAN 12'-0" X 12'-0" ON CENTER; 2.) FOR ESSENTIAL SERVICES BUILDINGS, PLACE BRACING ASSEMBLIES NOT MORE THAN 8'-0" X 12'-0" ON CENTER: 3.) PROVIDE BRACING ASSEMBLIES AT LOCATIONS NOT MORE THAN 1/2 THE AFOREMENTIONED SPACINGS, FROM EACH PERIMETER WALL AND AT THE EDGE OF VERICAL CEILING OFFSETS. THE SLOPE OF THESE WIRES SHALL NOT EXCEED 45 DEGREES FROM THE PLANE OF THE CEILING AND SHALL BE TAUT. SPLICES IN BRACING WIRES ARE NOT TO BE PERMITTED. 4.) SUSPENDED ACOUSTICAL CEILING SYSTEMS WITH A CEILING AREA OF 144 SQUARE FEET OR LESS. AND FIRE RATED SUSPENDED ACOUSTICAL CEILINGS SYSTEMS WITH A CEILING AREA OF 96 SQUARE FEET OR LESS, SURROUNDED BY WALLS WHICH CONNECT DIRECTLY TO THE STRUCTURE ABOVE, DO NOT REQUIRE BRACING ASSEMBLIES WHEN ATTACHED TO TWO ADJACENT WALLS.
- FASTEN HANGER WIRES WITH NOT LESS THAN THREE (3) TIGHT TURNS. FASTEN BRACING WIRES WITH 7. FOUR (4) TIGHT TURNS. MAKE ALL TIGHT TURNS WITHIN A DISTANCE OF 1-1/2". HANGER OR BRACING WIRE ANCHORS TO THE STRUCTURE SHOULD BE INSTALLED IN SUCH A MANNER THAT THE DIRECTION OF THE ANCHOR ALIGNS AS CLOSELY AS POSSIBLE WITH THE DIRECTION OF THE WIRE. NOTE: WIRE TURNS MADE BY MACHINE WHERE BOTH STRANDS HAVE BEEN DEFORMED OR BENT IN WRAPPING CAN WAIVE THE 1-1/2" REQUIREMENT, BUT THE NUMBER OF TURNS SHOULD BE MAINTAINED, AND BE AS TIGHT AS POSSIBLE.
- 8. SEPARATE ALL CEILING HANGER AND BRACING WIRES AT LEAST 6" FROM ALL UNBRACED DUCTS, PIPES, CONDUIT, ETC.
- 9. ATTACH ALL LIGHT FIXTURES AND CEILING MOUNTED AIR TERMINALS, TO THE CEILING GRID RUNNERS TO RESIST A HORIZONTAL FORCE EQUAL TO THE WEIGHT OF THE FIXTURES. SCREWS OR APPROVED
- 10. FLUSH OR RECESSED LIGHT FIXTURES AND AIR TERMINALS, WEIGHING LESS THAN 56 LBS., MAY BE SUPPORTED DIRECTLY ON THE RUNNERS OF A HEAVY DUTY GRID SYSTEM BUT, IN ADDITION, THEY MUST HAVE A MINIMUM OF TWO (2) #12 GAGE SLACK SAFETY WIRES ATTACHED TO THE FIXTURE AT DIAGONAL CORNERS AND ANCHORED TO THE STRUCTURE ABOVE. ALL 4'-0'' X 4'-0'' LIGHT FIXTURES MUST HAVE SLACK SAFETY WIRES AT EACH CORNER.
- 11. ALL FLUSH OR RECESSED LIGHT FIXTURES AND AIR TERMINALS WEIGHING 56 LBS. OR MORE MUST BE INDEPENDENTLY SUPPORTED BY NOT LESS THAN FOUR (4) TAUT #12 WIRES, EACH ATTACHED TO THE FIXTURE AND TO THE STRUCTURE ABOVE REGARDLESS OF THE TYPE OF CEILING GRID SYSTEM USED. THE FOUR (4) TAUT #12 GAGE WIRES, INCLUDING THEIR ATTACHMENT TO THE STRUCTURE ABOVE, MUST BE CÀPABLE OF SUPPORTING FOUR (4) TIMES THE WEIGHT OF THE UNIT.
- 12. ALL FIXTURES AND AIR TERMINALS SUPPORTED ON HEAVY DUTY GRID SYSTEMS MUST BE INDEPENDENTLY SUPPORTED BY NOT LESS THAN FOUR (4) TAUT #12 GAGE WIRES EACH ATTACHED TO THE FIXTURE OR TERMINAL, AND TO THE STRUCTURE ABOVE
- 13. SUPPORT SURFACE MOUNTED LIGHT FIXTURES BY AT LEAST TWO POSITIVE DEVICES WHICH SURROUND THE CEILING RUNNER AND WHICH ARE EACH SUPPORTED FROM THE STRUCTURE ABOVE BY A #12 GAGE WIRE. SPRING CLIPS OR CLAMPS THAT CONNECT ONLY TO THE RUNNER ARE NOT ACCEPTABLE. PROVIDE ADDITIONAL SUPPORTS WHEN LIGHT FIXTURES ARE 8'-0" OR LONGER.
- 14. SUPPORT PENDANT MOUNTED LIGHT FIXTURES DIRECTLY FROM THE STRUCTURE ABOVE WITH HANGER WIRES OR CABLES PASSING THROUGH EACH PENDANT HANGER AND CAPABLE OF SUPPORTING FOUR (4) TIMES THE WEIGHT OF THE FIXTURE. A BRACING ASSEMBLY IS REQUIRED WHERE THE PENDANT HANGER PENETRATES THE CEILING. SPECIAL DETAILS ARE REQUIRED TO ATTACH THE PENDANT HANGER TO THE BRACING ASSEMBLY TO TRANSMIT HORIZONTAL FORCES.
- 15. T-BAR IN ALL LOCATIONS TO BE HEAVY DUTY SYSTEM.


ANGLE BRACING TO STRUCTURE

Scale: 3'' = 1' - 0''

FASTENING BASE MATERIAL	TYPE OF FASTENER	MIN. EMBEDMENT
20 GAGE MIN. METAL DECK WITH CONCRETE FILL — NORMAL WEIGHT — 3000 psi MIN.		
20 GAGE MIN. METAL DECK WITH CONCRETE FILL — LIGHT WEIGHT — 3000 psi MIN.	1/4" Ø HILTI KWIK BOLT II	2"
CONCRETE SLAB/BEAM - NORMAL WEIGHT - 3000 psi MIN.		

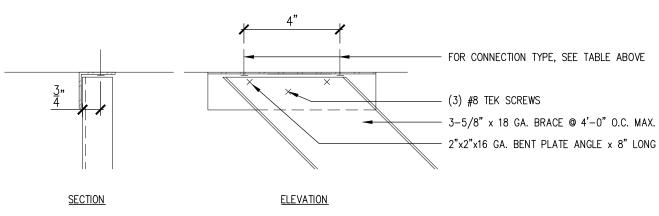


FASTENING BASE MATERIAL	TYPE OF FASTENER	MIN. EMBEDMENT
20 GAGE MIN. METAL DECK WITH CONCRETE FILL — NORMAL WEIGHT — 3000 psi MIN.	1/4" Ø HILTI KWIK BOLT II	1 – 1/8"
20 GAGE MIN. METAL DECK WITH CONCRETE FILL — LIGHT WEIGHT — 3000 psi MIN.	1/4" Ø HILTI KWIK BOLT II	2"
CONCRETE SLAB/BEAM - NORMAL WEIGHT - 3000 psi MIN.	1/4" Ø HILTI KWIK BOLT II	1 – 1/8"
STEEL BEAM	HILTI X-AL-H27 P8	THROUGH STEEL OR 1/2" MIN.

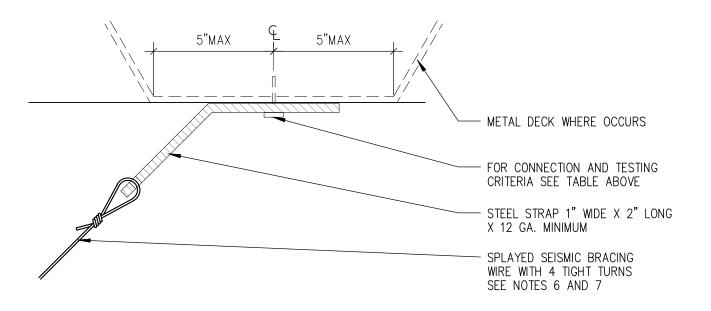

## ANGLED WIRE SUPPORT FOR CEILING SYSTEMS

Scale: 3'' = 1' - 0''


FASTENING BASE MATERIAL	TYPE OF FASTENER	MIN. EMBEDMENT
20 GAGE MIN. METAL DECK WITH CONCRETE FILL — NORMAL WEIGHT — 3000 psi MIN.	1/4" Ø HILTI KWK BOLT II	1 – 1/8"
20 GAGE MIN. METAL DECK WITH CONCRETE FILL — LIGHT WEIGHT — 3000 psi MIN.	1/4" Ø HILTI KWK BOLT II	1 – 1/8"
CONCRETE SLAB/BEAM - NORMAL WEIGHT - 3000 psi MIN.	1/4" Ø HILTI KWIK BOLT II	1 - 1/8"

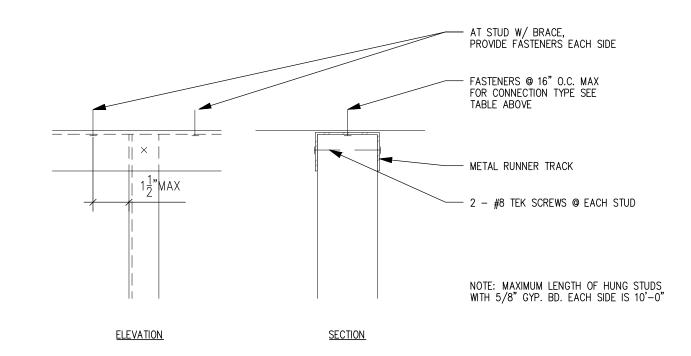

## STUD CONNECTION TO STRUCTURE


Scale: 3'' = 1' - 0''

FASTENING BASE MATERIAL	TYPE OF FASTENER	MIN. EMBEDMENT
20 GAGE MIN. METAL DECK WITH CONCRETE FILL — NORMAL WEIGHT — 3000 psi MIN.	HILTI CC 27DNI 27 P8T	1"
20 GAGE MIN. METAL DECK WITH CONCRETE FILL — LIGHT WEIGHT — 3000 psi MIN.	HILTI CC 27DNI 32 B8T	1-1/4"
CONCRETE SLAB/BEAM — NORMAL WEIGHT — 3000 psi MIN.	HILTI CC 27DNI 27 P8T	1"
STEEL BEAM — FLANGE GREATER THAN OR EQUAL TO 3/4" THICK	HILTI X-AL-H27 P8	1/2" MIN.
STEEL BEAM — FLANGE BETWEEN 3/8" AND 9/16" THICK	HILTI X-AL-H22 P8	THROUGH STEEL

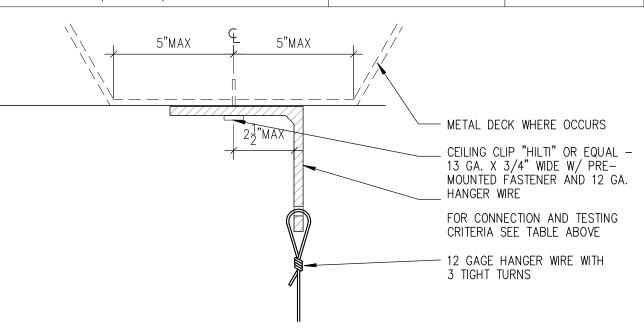


## VERTICAL WIRE SUPPORT FOR CEILING SYSTEMS

Scale: 3'' = 1' - 0''

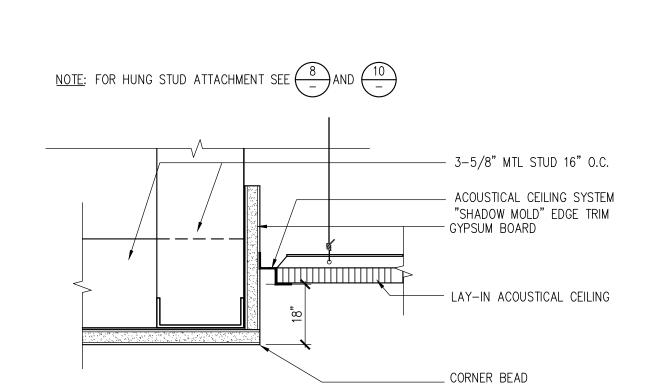


## GYPSUM BOARD/ LAY-IN CEILING TRANSITION

Scale: 3'' = 1'-0''

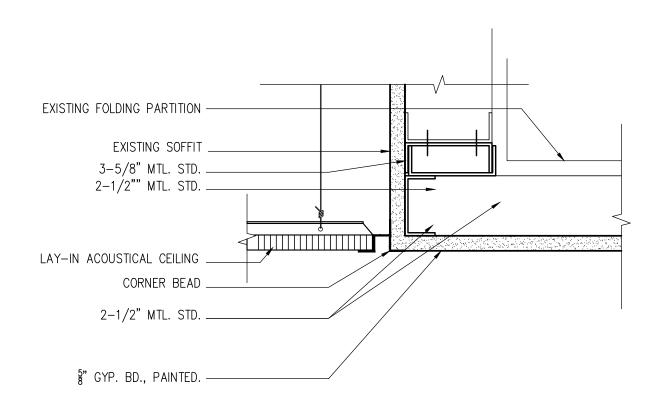


### FOLDING WALL PARTITION SOFFIT

Scale: 3'' = 1'-0''

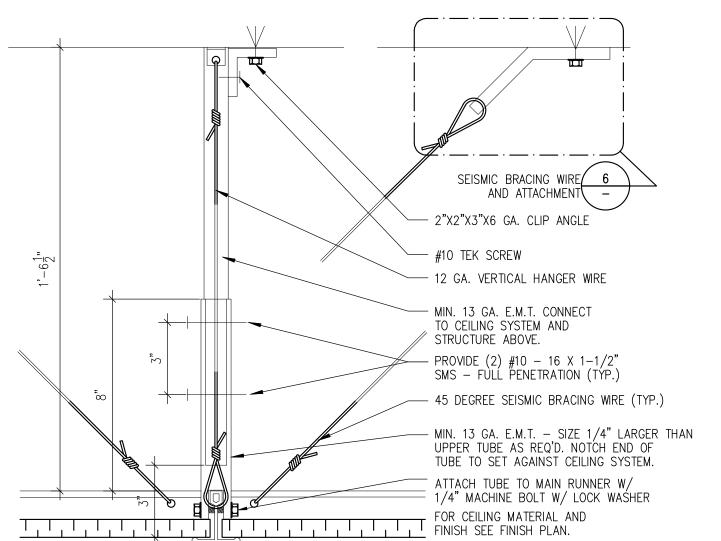


### TYPICAL LAY-IN CEILING E.M.T. SUPPORT

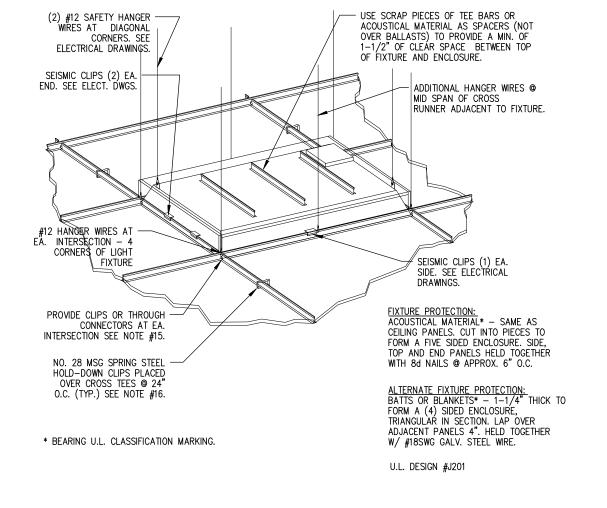


# TYPICAL CEILING FIXTURE INSTALLATION

Scale: NTS

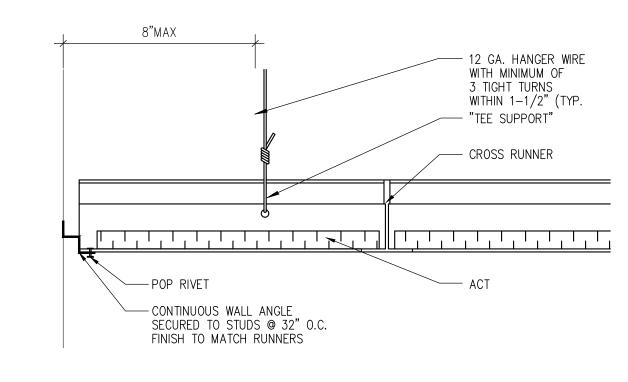

## TYPICAL LAY-IN CEILING @ ATTACHED END

Scale: 3'' = 1' - 0''

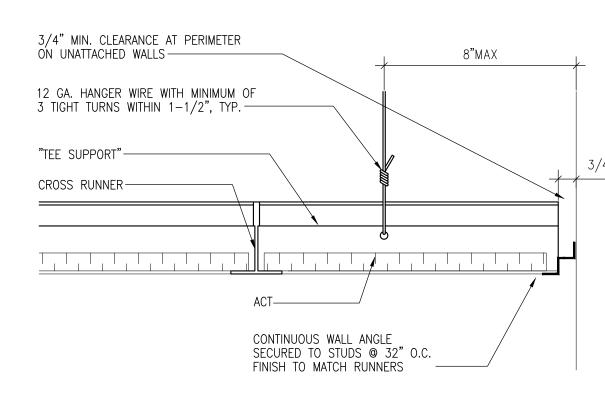

Seal:

Drawing Description: CEILING **DETAILS** 

**A6.0** 

TYPICAL LAY-IN CEILING @ UNATTACHED END Scale: 3'' = 1' - 0''Scale: 3'' = 1' - 0''

### Architects:

mkthink.com

### MKTHINK

Roundhouse One, 1500 Sansome Street San Francisco, CA 94111 p 415 402 0888 f 415 288 3383

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# Project:

Media Services Relocation 200 McAllister Street San Francisco, CA

### Project Number: 491-142



## UC Hastings College of Law 200 McAllister Street San Francisco, CA

Rev.	Issue	Date
	BID SET	1.9.14

# **AS NOTED**

Date: Drawn By: \_\_

Checked By: --Sheet Number:

# NEW 3 & METAL STUD -ANGLE BRACE @ 45 DEGREES TO SLAB ABOVE GYPSUM BOARD -ACOUSTICAL CEILING SYSTEM "SHADOW MOLD" EDGE TRIM EXISTING LAY-IN ACOUSTICAL - 3-5/8" MTL STUD 16" O.C. CEILING ACOUSTICAL CEILING SYSTEM "SHADOW MOLD" EDGE TRIM GYPSUM BOARD LAY-IN ACOUSTICAL CEILING CORNER BEAD -- CORNER BEAD

## GYPSUM BOARD/ LAY-IN CEILING SOFFIT TRANSITION

(E) FLOOR TO REMAIN

TYPE B: FULL HEIGHT ACOUSTIC PARTITION

-ACOUSTICAL SEALANT. BOTH SIDES, TOP AND BOTTOM, TYP.

- DOUBLE DEFLECTION TRACK ASSEMBLY. ANCHOR TOP TRACK

SEE CLG. PLAN

TO STRUCTURE ABOVE AS REQUIRED.

RETURN. 1'-4" O.C. MAX.

STRUCTURE. TYP.

— CONTINUOUS CEILING RUNNER W/ 1-1/4" LEGS.

RESILIENT CHANNEL MOUNTED VERTICALLY, 24" O.C.

- 2-1/2" 20 GA. STL. STUDS W/ 1-1/4" LEGS AND 3/8"

— 3" SOUND ATTENUATING FIBERGLASS BLANKET TO

POWDER DRIVEN FASTENERS 0.1770 X 1-1/2"

- CONTINUOUS FLOOR RUNNER W/ 1-1/4" LEGS.

EMBEDMENT TO SLAB AT 2'-0" O.C. MAX. AND 6" FROM

Scale: 3'' = 1'-0''

RETURN. 1'-4" O.C. MAX. STRUCTURE. TYP. -5/8" GYPSUM BOARD FULL HEIGHT TO UNDERSIDE OF STRUCTURE, BOTH SIDES. SCREW AT 8" O.C. ALONG EDGES AND AT 12" O.C. IN THE FIELD OF THE BOARD. USE 1" LONG TYPE "S" SELF-TAPPING STL. SCREWS AS ALL ENDS. (E) FLOOR TO REMAIN

ACOUSTICAL SEALANT. BOTH SIDES, TOP AND BOTTOM, TYP. - DOUBLE DEFLECTION TRACK ASSEMBLY. ANCHOR TOP TRACK TO STRUCTURE ABOVE AS REQUIRED. -CONTINUOUS CEILING RUNNER W/ 1-1/4" LEGS. SEE CLG. PLAN  $\sqrt{3}-5/8$ " 20 GA. STL. STUDS W/ 1-1/4" LEGS AND 3/8" \_\_\_ 3" SOUND ATTENUATING FIBERGLASS BLANKET TO -5/8" GYPSUM BOARD FULL HEIGHT TO UNDERSIDE OF STRUCTURE, BOTH SIDES. SCREW AT 8" O.C. ALONG EDGES AND AT 12" O.C. IN THE FIELD OF THE BOARD. USE 1" LONG TYPE "S" SELF-TAPPING STL. SCREWS AS -POWDER DRIVEN FASTENERS 0.1770 X 1-1/2" EMBEDMENT TO SLAB AT 2'-0" O.C. MAX. AND 6" FROM CONTINUOUS FLOOR RUNNER W/ 1-1/4" LEGS.

TYPE A: FULL HEIGHT ACOUSTIC PARTITION

WALL PARTITION TYPES (SEE 2B FOR ADDTIONAL WALL PARTITION TYPES) Scale: 1-1/2" = 1'- 0"

STL. STUD BLOCKING, WHERE CEILING OCCURS, CUT FLANGES BEND WEB UP

 $\overline{\phantom{a}}$  3-5/8" 20 GA. STL. STUDS W/ 1-1/4" LEGS AND 3/8" RETURN. 1'-4"

1" LONG TYPE "S" SELF-TAPPING STL. SCREWS AS INDICATED.

-5/8" GYPSUM BOARD FULL HEIGHT TO UNDERSIDE OF STRUCT. SCREW AT

POWDER DRIVEN FASTENERS 0.1770 X 1-1/2" EMBEDMENT TO SLAB AT

CONTINUOUS FLOOR RUNNER W/ 1-1/4" LEGS. 3-5/8" 20 GA. STL STD.

8" O.C. ALONG EDGES AND AT 12" O.C. IN THE FIELD OF THE BOARD. USE

SEE CLG. PLAN

---- DEFLECTION TRACK ASSEMBLY

and fasten to Stl. Studs W/ (2) #10 S.M.S.

2'-0" O.C. MAX. AND 6" FROM ALL ENDS. —BASE, SEE FINISH SCHEDULE.

(E) FLOOR TO REMAIN

TYPE C: CEILING HEIGHT PARTITION

HEAD -

FRAMELESS HEAD GLAZING DETAIL Scale: 3'' = 1'-0''

─ §" GYP. BD., PAINTED.

- CORNER BEAD, TYP.

SOLID, CONT. BLOCKING AS REQUIRED

PER MANF. REDOMMENDATIONS.

- CONT. CHANNEL, ANCHOR TO MTL STUD

MKTHINK

### Architects:

MKTHINK

Roundhouse One, 1500 Sansome Street San Francisco, CA 94111 p 415 402 0888

f 415 288 3383 mkthink.com

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San Francisco, CA



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Rev. Issue Date BID SET 1.9.14

Scale: AS NOTED


**Drawing Description:** 

Date:

Sheet Number:

Drawn-By: Checked\_By:

**DETAILS** 

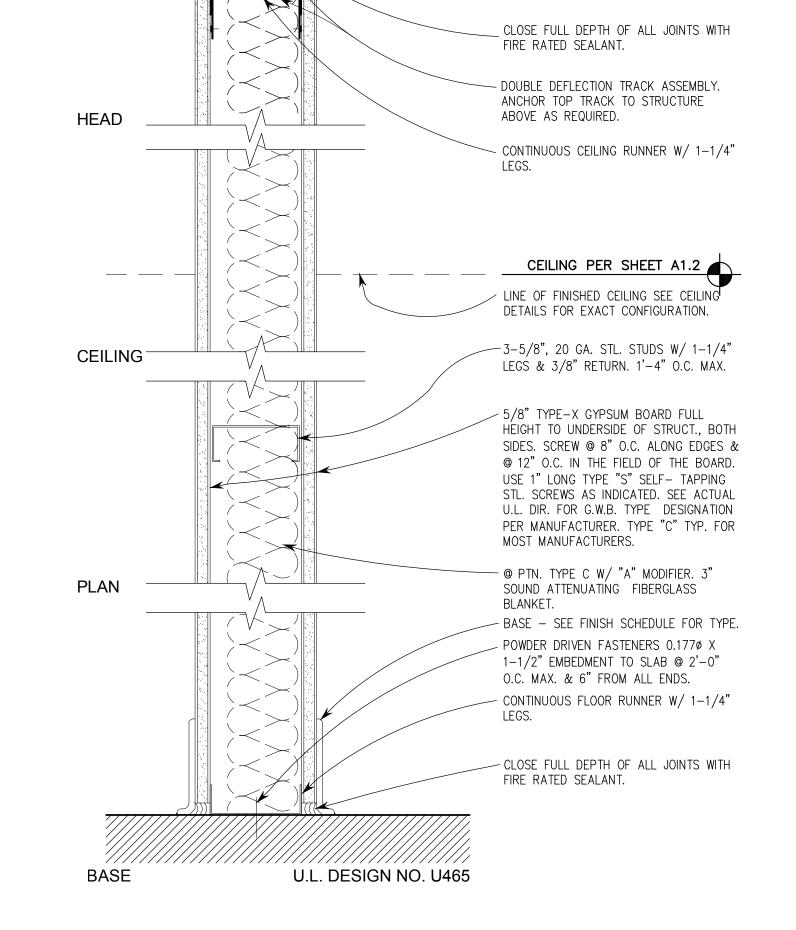

NOTE: SCRIBE PARTITION HEAD

NOTED OTHERWISE.

CONTINUOUSLY TO STRUCTURE, UNLESS

TYPE D: 1 HR FIRE-RATED NON-LOAD BEARING PARTITION

Scale: 1-1/2'' = 1'-0''

 $-\frac{1}{2}$ " THK. CLEAR TEMPERED GLASS, TYP.